PART II - CHAPTER P - COMPLETION REPORT

RECORD MAPPING DEPARTMENT MARINE BARRACKS, NEW RIVER, N. C.

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8" X 11" linen (bound on left)

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8.01 Final status

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Section P-1 Introduction

P-101 At various times the Project Manager requested instructions from the Officer in Charge concerning preparation of record drawings. Notice was received that it would be necessary to prepare record drawings and it was advised that sample drawings and specifications be prepared and submitted. A preliminary scheme and approximate scope of the work was submitted by use of a sample 1"= 50' map, Quadrangle 160 G-3, G-4 and an index map M.B. Drawing No. 1174.

These were approved by the Officer in Charge, April 12, 1942, deleting the outlying areas.

P-102 The approved system was based on the following considerations and was essentially as follows:

All horizontal surveys for the New River Reservation are based on the North Carolina System of Plane Coordinates. The entire area has been divided into rectangles 10,000 feet north and south, and 15,000 feet east and west. For the purpose of basic mapping at 500' to the inch, these rectangles fit a standard Navy drawing with just sufficient room outside the limits of the rectangle for legend, notes, etc. This layout is shown on two 1,20,000 scale maps M.B. Dwg. No. 1174 and M. B. Dwg. No. 2157. These retangles are numbered in such a manner that the system may be extended in all directions in order that the 500' scale maps, and their numbering system, may also serve as a perpetual index of larger scale maps and other survey data.

For the purpose of Record Mapping of utilities, the quadrangles were subdivided further into foru rectangles, to scale of 1"= 50', covering an area 1000 ft. north and south, by 1500 ft. east and west, and fitting a standard Navy sheet. These rectangles are identified in each next larger rectangle by a system of numbering, starting with No. 1 in the upper right hand corner and

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running clock-wise up to and including No. 4. This method furnished an easy access to maps filed by quadrangle number.

Elevations shown are referred to mean sea level.

P-1.03 To carry out this plan a record mapping department was created. From a letter of March 28, 1942, to Engineers, Contract NOy-4751, Subject: Record Dwgs. "It is not intended that an additional force of workmen be employed for this purpose, but that a portion of your present force will be used, as available." Signed, Madison Nichols, Officer In Charge. These instructions were carried out and men were transferred, either permanently or temporarily from other departments. The average force in this department was 3 men.

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Section P-2 Sources of information

Section P-2.0/In view of the fact that all construction inspection was under the supervision of the Navy, we were entirely dependent upon their records for "as-built" data. This method is not the most desirable and caused considerable delay before a steady flow of information could be established. Wherever possible, the Navy notes were used as a check as well as a source of information. They served also to show where construction differed from plan; and in all cases, the work was mapped according to the "as-built" information furnished. Our own survey field notes furnished a large amount of the control for the maps, but the field work done by this organization solely for the purpose of record mapping was kept to a minimum. Where as-built field notes were not available the work was plotted as shown on the plan and verified as far as possible by a field inspection before the map was inked. When larger scale maps were not on hand,

A shore lines were transferred graphically from sheets 5049 and 5050.

June U. S. Coast and Geodetic Survey

Compilation of Aerial Photographs, Sheets 5049 and 5050

Photographs by: U. S. Army Air Corps

Compilation by U. S. Coast and Geodetic Survey

State: North Carolina

General locality: Atlantic Coast

Locality: New River and Alligator Bay to Bear Inlet

Time and date of photographs:

10:30 a. m., 1:30 p.m. January 29, 1933

Scale: 1:20,000 1"= 1666.67 feet

Frequent reference was also made to U.S.C. & G.S. Quadrangle 777 particularly during sweeping and dredging operations in New River and Courthouse Bay.

| located |
| All channels, markers and lights, have been shown on l"= 500' maps.

A valuable source of information during the entire job was the aerial mosaic on titled:

Jacksonville, North Carolina

Pilot Mears, H. F. N.A.P.

Photo Edgett, M.M. P 1/c

Baran, A. Pl/c

Date: February 12, 1941 F.L. 81/4 F.56

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Property maps, scale 1"= 660', by Boney and Broadfoot, Architects and Engineers at Wilmington, N. C., were also used. These maps were drawn under contract NOy-4717 prior to the Carr & J. E. Greiner Co. contract, and were not coordinated.

Section P-3 General Area Map

P-3.01 The General Area Map, M. B. Dwg. No. 138, was begun August 15, 1941 with the intent of furnishing a unified picture of all projects on the reservation. Natural features were photographed from Coast & Geodetic Qradrangle photographs compilations previously referred to Site plans frequently were reduced in scale by the same method prior to tracing on this buildings & roads

1"= 2000' map. In many cases areas were shown on this map before construction had begun. Naturally, these are inaccuracies in scale in a map so constructed and this fact was recorded on the map. However, its cost was more than repaid by its useful ness to all departments.

P-3.02 The Record Mapping Department was charged with keeping the general area map up to date. A considerable amount of information was furnished by Col. W. P. T. Hill and as various units of the Marine Corps began training on the base this map was very valuable from a military standpoint. Machine gun ranges, fire observation towers, impact areas, roads, etc. were plotted with sufficient accuracy to guide troops on maneuvers and quickly orient officers and men, thus saving valuable time and avoiding needless confusion.

The Quadrangle numbering system is also shown on this map thus tying it in with all subsequent mapping work and furnishing a key to the system for the entire reservation.

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Section P-4

Section P-4 EXTRACTS FROM SPECIFICATIONS - Not all capital letters

FROM SPECIFICATION NO. 1000 titled:

"SPECIFICATIONS FOR THE PREPARATION OF RECORD DRAWINGS"

MARINE BARRACKS

NEW RIVER, NORTH CAROLINA

P-401. 3. PREPARATION & GENERAL STYLE OF DRAWINGS

Drawings generally will be divided into two groups as follows:

- (a) Original Drawings: Original drawings shall be made on the best quality of white paper with muslin backing.
- (b) Linen Tracings: Linen tracings shall be made on the best quality linen tracing cloth.

Unnecessary work shall be avoided. Simplicity shall be practiced in every detail in inking tracing; lines shall never be shaded; lettering shall be plain and simple, and shall be limited to the amount required for clarity in reading the drawings. Ornateness in rendering borders or other figures will not be permitted; standard north points, symbol, and title blocks shall be used.


4. SIZES OF DRAWINGS:

- (a) Original drawings on muslin backed paper shall be $33\frac{1}{2} \times 45\frac{1}{2}$ overall.
 - (b) Linen tracings shall be 29" x 35", overall.

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	- 1 - 1 - 1 - 1 - 1 - 1 - 1 - 1 - 1 - 1		
	Section P-5 1"= 500	scale maps	
	P-5.01		
		1 OF 1" = 500' N	IAPS
	ORIGINAL DWG.	TRACI	
	QUADRANGLE NO.	Y. & D. No.	
	98 /		
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space space	99	228, 332 228, 335	2 /
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	100	228, 333	3 /
u u	120	228, 336	6.
	101 x	228,412	76
	102		
	122 X	2 2 8 , 4 1 3	77
	137		72
	137	228, 408 228, 350	20
	138		u—
	158	228,419	81
	139 /	228, 337	7.
	159		
	140	228,338	8.0
	142 x	228,409	73
	177	228,400	70. /
	197 🗡	228,401	71./
	178		
	198	228, 344	147
	179	228,341	
	199	228, 345	15 🗸
	180 /	228, 342	12 75
		228,343	_ 13
	181.	228, 355	25 /
		228,414	78
	182 ×	228,415	79
	217 1	228, 346	16
	237		
	218	228, 347	17.
	238		
	219 /	228,348	18 V
	220 /	228,349	. 19 /
		228, 416	80
	221 (241 Total 42	1 200,710	_ Total 33



P-502 The original drawing of 1"= 500' covers an area 20,000 north and south by 15,000 east and west, and contains the following data:

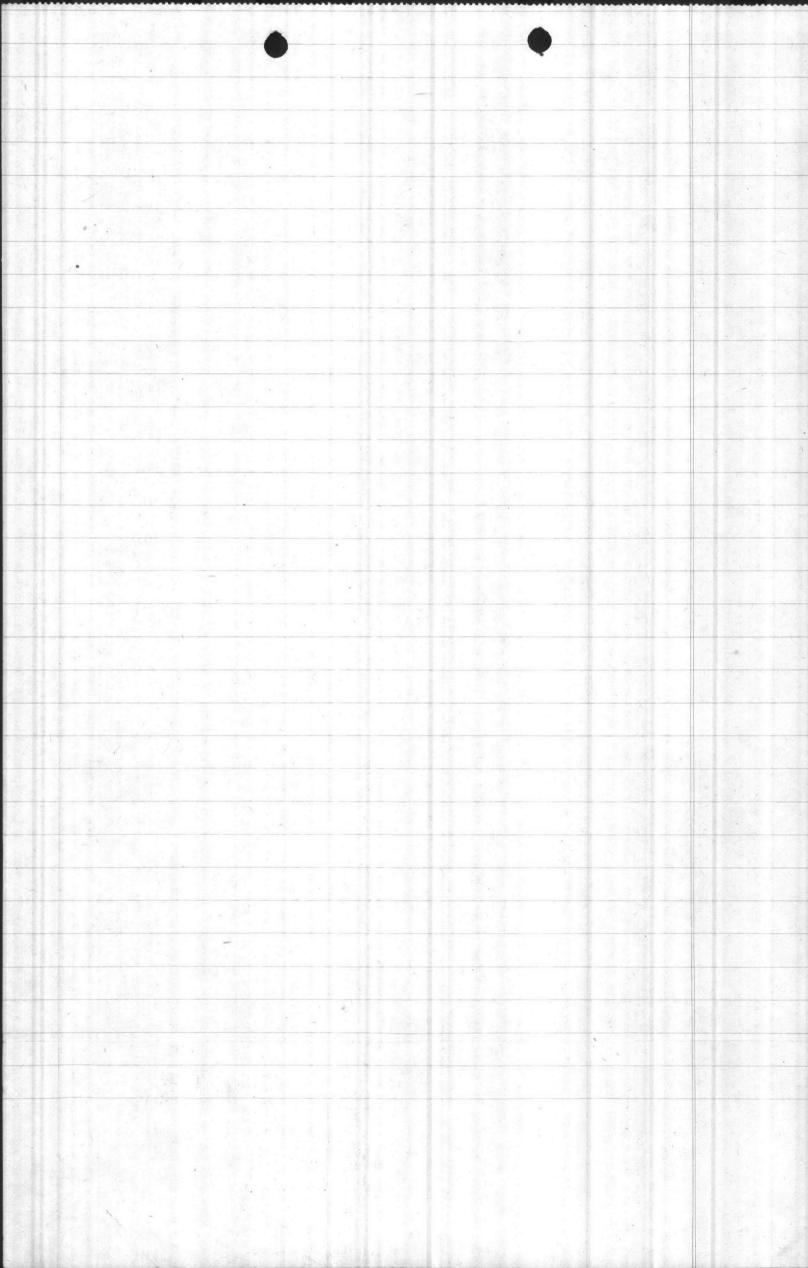Building outline
Building numbering plan approved
Road right-of-way lines and names
Railroads
Natural features
Triangulation net
New River channel, markers, and lights

Accurate control was established for all 1"= 500' maps by means of triangulation and by coordinated traverses. Monuments set on the Reservation Boundary or in areas not covered by 1"= 50' maps were plotted accurately and coordinates tabulated. Certain boundary line courses and distances also were shown.

P-503 After the basic 500' scale maps were completed several reproductions were made on tracing cloth and the various departments plotted their main utility layouts resulting in small scale planning and operating maps, showing respectively the various utilities. The utilities mapped and P.W. Nos. assigned were as follows:

UTILITY	SUFFIX TO P.W. NO.
Electrical Distribution	Е
Heating, Mains and Plants	H
Street lighting, circuits	L
Sewerage Systems	S
Communications lines	T
Water Collection and Distribution	W
Propane Gas	G

(Thus a sewerage map drawn on a reproduction of P.W. Dwg. No. 10 would be numbered P.W.10-S)

anning & operating maps.
Key Maps Prepared are as follows:

P. W. NO.	QUADRANGLE NO.	TO BE MAPPED
1 3	98 100	E, H, L, S, T, W,
4	118	E,T, W
5	119	E, L, S, T, W
16	120	E, S, W
7	139	E, L, S, T, W
8	140	E, H, S, T, W
9	159 /	W

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P.W. NO.	QUAD. NO.	UTILITIES MAPPED		
10	160	E, G, H, L, S, T, W E, T		
17	218	E, T		
18	159	W		

Section P-6

P-601 1"= 50' scale Maps

This phase of the work was by far the most extensive. The original authorization of this project, as instructed by the Officer in Charge, on M.B. Dwg.

No. 1174, April 1942, included only the Main Division Area, Industrial Area,
and Tent Camps, but was later expanded (August 25, 1942) by the Officer in Charge,
to twice the original assignment thus including the following areas:

Amphibian Base, Tent Camp, Rifle Range, Mumford Point Tent Camp, and Officers

Quarters Area.

P-602 The 50' scale maps constitute the basic final record of utilities and show the following data:

Outlines of buildings and other structures Culverts and invert elevations Bridges Water Mains, including valves, fire hydrants, tanks, etc. As-built elevations where such information was available Sewers Gas lines Steam lines Pole lines Underground electric and communication lines Gasoline and fuel oil lines and pumps Permanent coordinated monuments and triangulation stations Bench Marks Areaways and pits Wells Storm drains Railroad tracks, roads and sidewalks

P-603 A color scheme was selected to comply as closely with Bureau of Yards and Docks standard for operating maps as possible, diverging only where it was apparent that the standard color would not furnish satisfactory photostatic reproduction. The final scheme as set forth in Specification No. 1000, Addendum No. 1 is as follows:

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Fresh Water	Blue
Salt Water	Green
Steam Mains	Orange
Sewers	Black
Propane Gas	Carmine
Fuel Oil	Carmine
Gasoline	violet
Electrical lines	Scarlet
Communications	Brown
Paved Roads and Sidewalks	Gray

P-604

TABULATION OF 11 1"= 50' SCALE MAPS

AREA	Qt	JADRANGLE	
Mumford Point Tent Camp	99	U-1, & U-2 U-3, & U-4	= tabulate thus
Amphibian Base Tent Camp Residential Area	118	A-3\ & A-4\) H-1\ H-2 L-3\ L-4 Q-1\ Q-2 Q-3\ Q-4 R-1\ R-2 R-3\ R-4 S-1\ S-2 S-3\ S-4 W-1\ W-2	double space
	139	X-1, X-2 X-3, X-4 D-1, D-2, E-3, E-4, J-3, J-4 O-1, O-2 O-3, O-4 T-1, T-2,	
Rifle Range	198	T-3, T-4 Q-1, Q-2, Q-3, Q-4 V-1, V-2, V-3, V-4 W-3, W-4	- double space
Dollar Doine 0	218	B-3 B-4	
Balloon Barrage & <	219	D-1, D-2, E-1, E-2	
	P	E-3, E-4 J-1, J-2 J-3, J-4, I-1, I-2 O-1, O-2 O-3, O-4	

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	AREA	QUADRANGLE	
	Tent Campe 1 8, 2	220 F-3, F-4 K-3, K-4	- double space
	Tent Camps 1 & 2	98 K-1, K-2, K-3, K-4 P-1, P-2 P-3, P-4	
		Q-3, Q-4 V-1, V-2 U-1 V-3, V-4 U-3	\$ U-2 -
i.N	2.28	118 A-1, A-2 A-3, A-4	double space
Industrial F	req Hospital Area	140 139 W-1, W-2	
The state of the s		W-3, W-4	
COLD COLD	The state of the s	160 C-1,C-2,	
	A Section of the Sect	C-3, C-4 B-1, B-2	
		G-1, G-2	
	and the second s	H-3, H-4	· H
	RegimentalBAreaing	140 P-3, P-4	
		UX-1, V-2, U-11	£ U- Z
		159 E-1, E-2	80-4
		160 A-1, A-2	
		A-3, A-4	
		B-3, B-4	
		F-1, F-2 F-3, F-4	
		G-3, G-4	
		K-1, K-2	
		K-3, K-4	
		L-1, L-2	
		L-3, L-4	
		M-3, M-4 Q-1, Q-2	
		Q-3, Q-4	
		V-1, V-2	
	Parachute Building &	140 R-3, R-4	
	Landing Field	118 R+1, R-2,	Ч и
		R-3, R-4 S-3, S-4	
			al: 79
	Hospital Area	139 X-1 & X-2	
		X-3 & X-4	
		the contract of the contract o	The second of the second
		Y-1 & Y-2	
		Y-3 & Y-4	
		11	Cont Long training on the contract contract to the contract
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Section P-8
P-8.01 Summary
To summarize briefly, there were completed,
with due regard to status of construction and information
available, the following:


1. One General Area Map tracing, 1"=2000' (See Sed. P-3)

2. Twenty one hard copy drawings, each covering
two 10000' x 15,000' quadrangles, scale 1"=500'


(See tabulation Sect. P-4)

3. Thirty-three tracings, each covering, one 10,000' x 15,000'
quadrangle , scale 1"=500'
(See tabulation Sect. P-6)

4. Seventy nime hard copy drawings, each covering two
1000' x 1500' quadrangles
(See tabulation Sect. P-6)

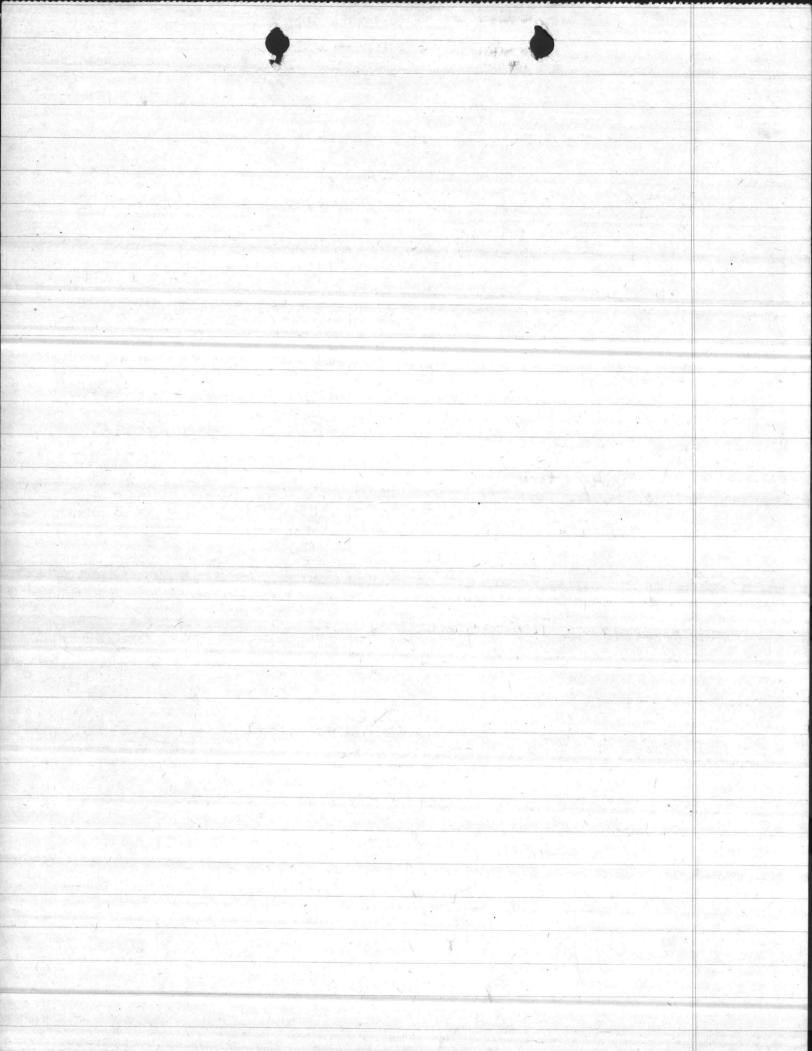

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	5.02 Gen. description
	5.03 Key Maps
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	6.01 Area covered
•	602 Information Plotted
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5.	Sect. P-4 Extracts from Specifications
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13	Sect P-7 Symbols
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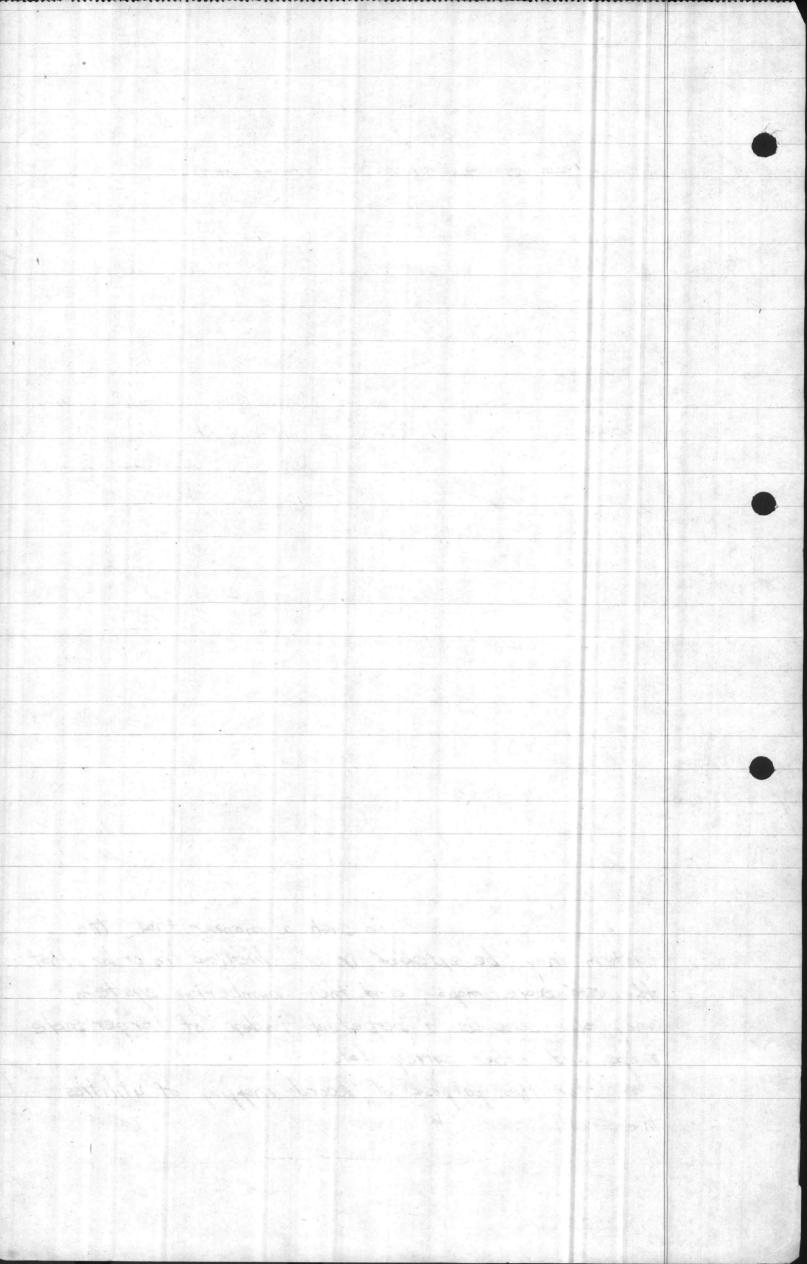


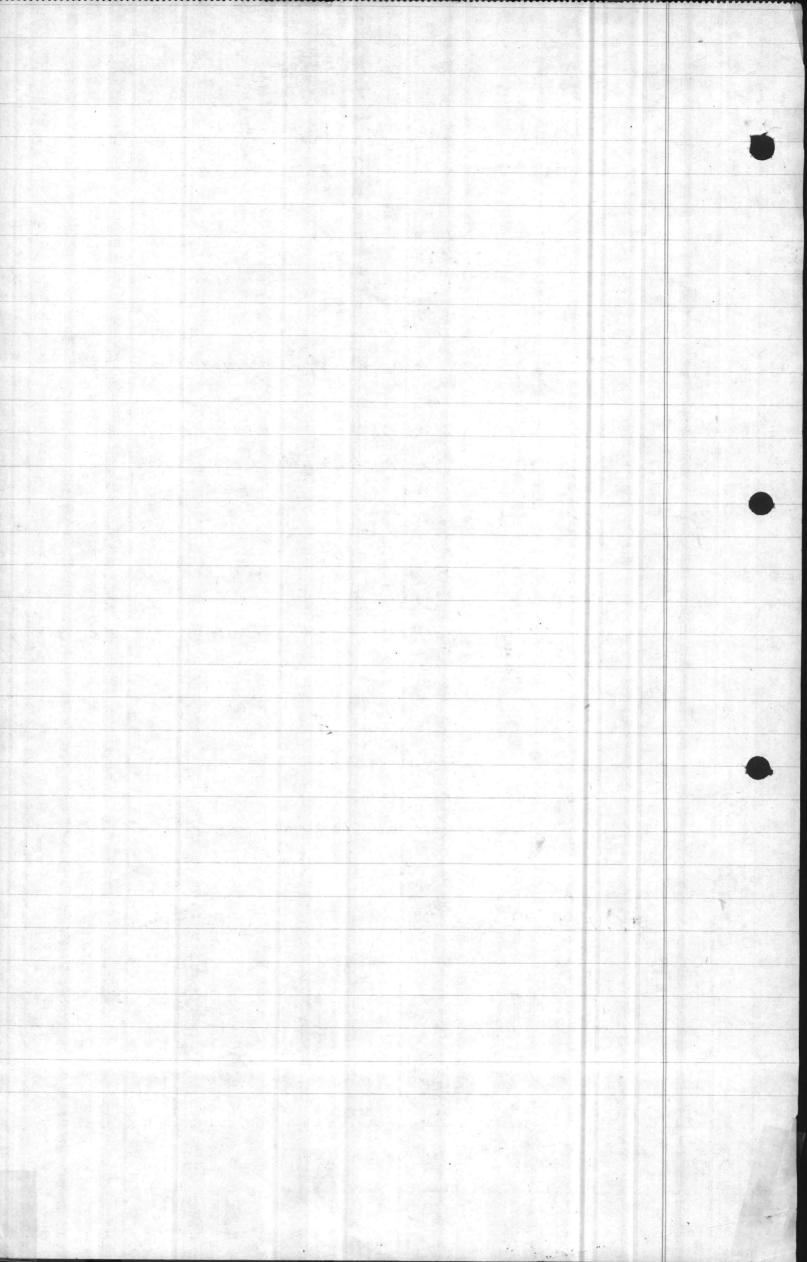Section P-1 Atranionstimes Introduction
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identified in each next larger rectangle by a system of numbering, starting with No. 1. in the upper right hand corner and running clock-wise up to and including No 4. This method furnishes an easy access to maps filed by guadrangle number.


Elevations shown are referred to Mean Sea Level.

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"It is not intended that an additional force of working he employed for this purpose, but that a portion of your present force well be used, as available.", signed of Madison Nie hols, Officer in Charge. These instructions were carried out and men were transferred either permanently or temporarily from other departments. The average force in this department was a men.


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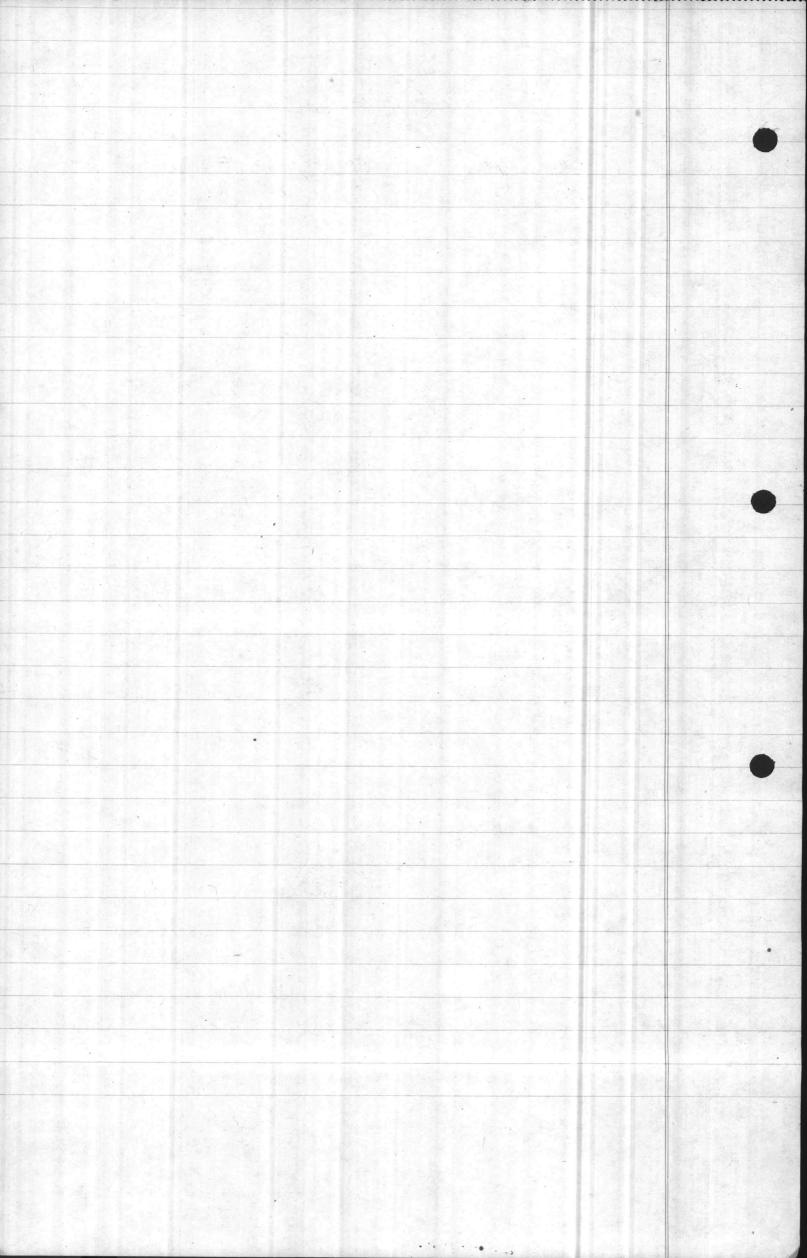
Compilation of Perial Photographs Photographs by U.S. Army Air Corps Compilation by U.S. Coast a Greatetic Survey State: North Caroling Cen. Locality: Allantic Coast Locality: New River & Alligator Bay to Bear Inlet Time & date of photographs 10:30 am. - 1:30 pm. Jan 29, 1933 Scale 1:20000 1"= 1666.67 feet. Frequent reference was also made to U.S. C. & G.S. guad. 777 particularly during sweeping and dredgying operations in New River and Courthouse Bay. V All channels, markers and lights have been shown on 1" 500' maps. A valuable source of information during the entire job was the aerial mosaic titled: Jacksonville, N.C. Pilot Means, H.F. N.A.P. Photo Edgett, M.M. P1/c Baran, A. P 1/c Date 2/12/41 F.L 8/4 F. 56 Property maps, scale 1"2660', by Bonny a Broad foot, architects & enqueers of Wilmington N.C., were also used. Threse maps were drawn under contract NOy 4717 prior to price! the Carr & S.E. Greiner Co. antract, and were not Coordinated.



Section P-3

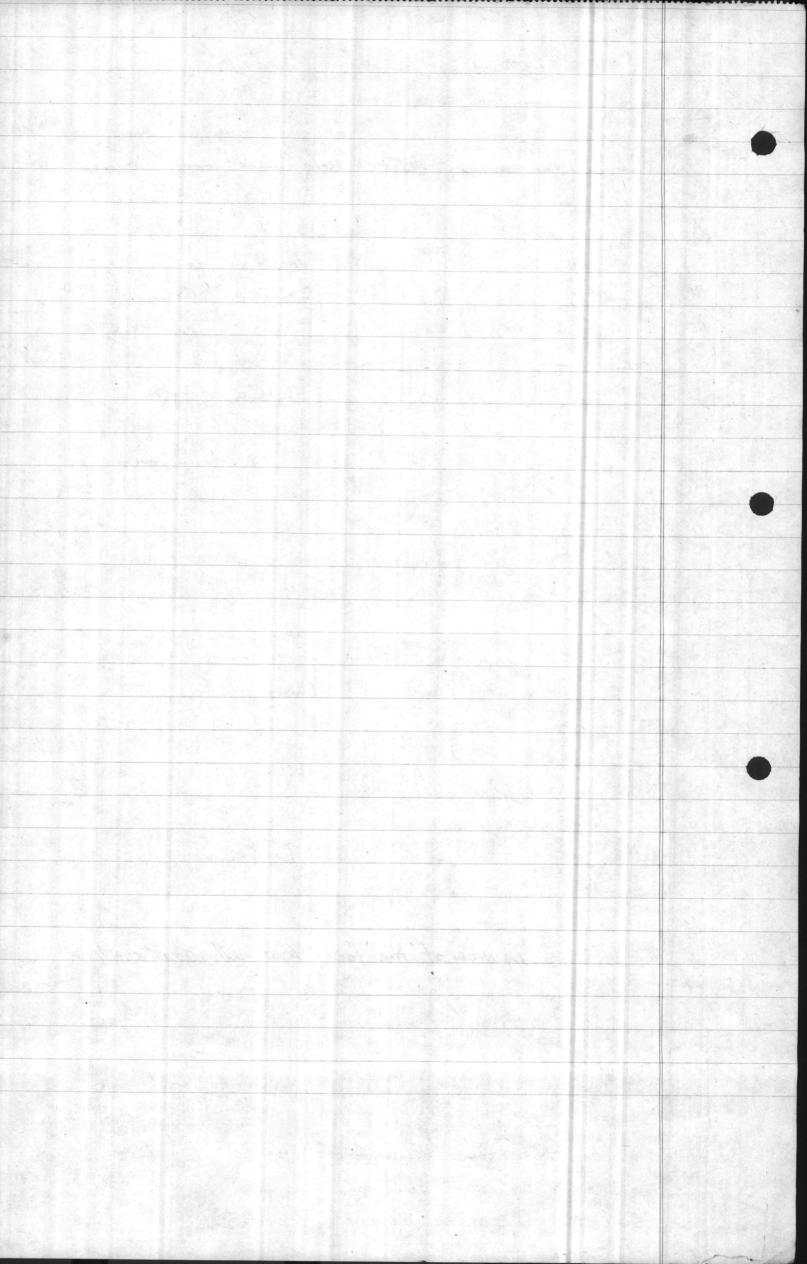P- 301 The General Arca Map, MB. dug. No 138 was begun Aug 15, 1941, with the intent of furnishing a unified picture of all projects on the reservation Natural features were photographed from Coast & Gradedie quadrangle 777 and airial photographic compilations previously referred to. Site plans (were frequently) reduced in scale by the same method prior to training on this 1" = 2000 map. In many cases areas were shown on this map before construction had begun. Naturally there are indervacies in scale in a map so constructed and this fact was recorded on the map. However, it's cost was more than repaid P-302 The Record Mapping Department took charged will I keeping the general area map up to date. A by Col, Hill and as various units of the Marine Corps began training on the base this map was very valuable From a military standpoint. Machine gun ranges, fire observation towers, impact areas, roads etc. Twere plotted with sufficient accuracy to quide troops on maneuvers and quickly orient officers and men, thus saving valuable time and avoiding needless con fusion.

The Quadrangle numbering system is also shown on this map thus tying it in with all subsequent mapping work and furnishing a key to the system for the entire reservation.

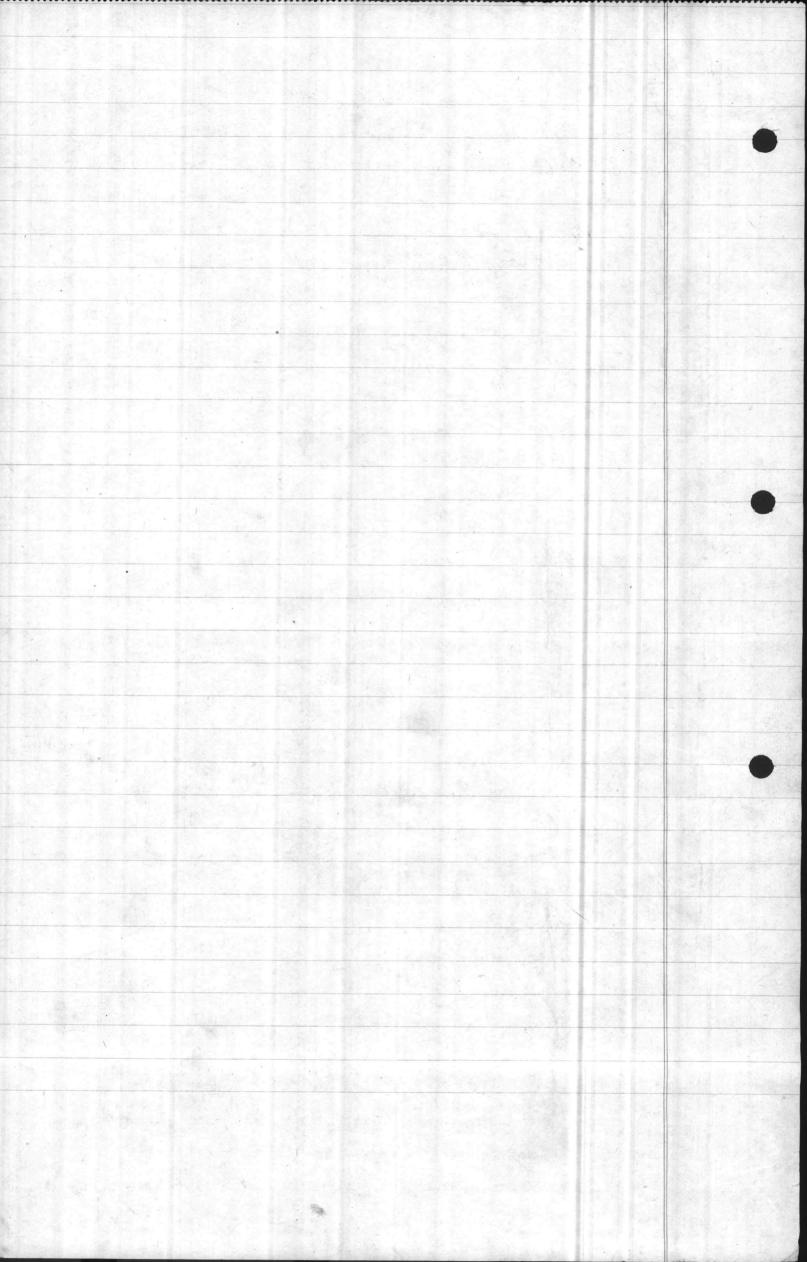

Section P-4

Extracts from Specifications

From Specification No 1000 titled:

"Specifications for the Preparation of Record Drawings
Marin Barracles

New River, North Carolina

P-401 3. PREPARATION & GENERAL STYLE OF DRAWINGS.

Drawings generally will be divided into two

groups as follows:

be made on the best quality of white paper with

muslin backing.


made on the best quality linen tracing shall be

title blocks shall be used.

4. SIZES OF DRAWINGS.

a) Original drawings on muslin backed paper shall be 331/2 x 451/2 overall.


(b) Linen tracings shall be 29" x 35", overall

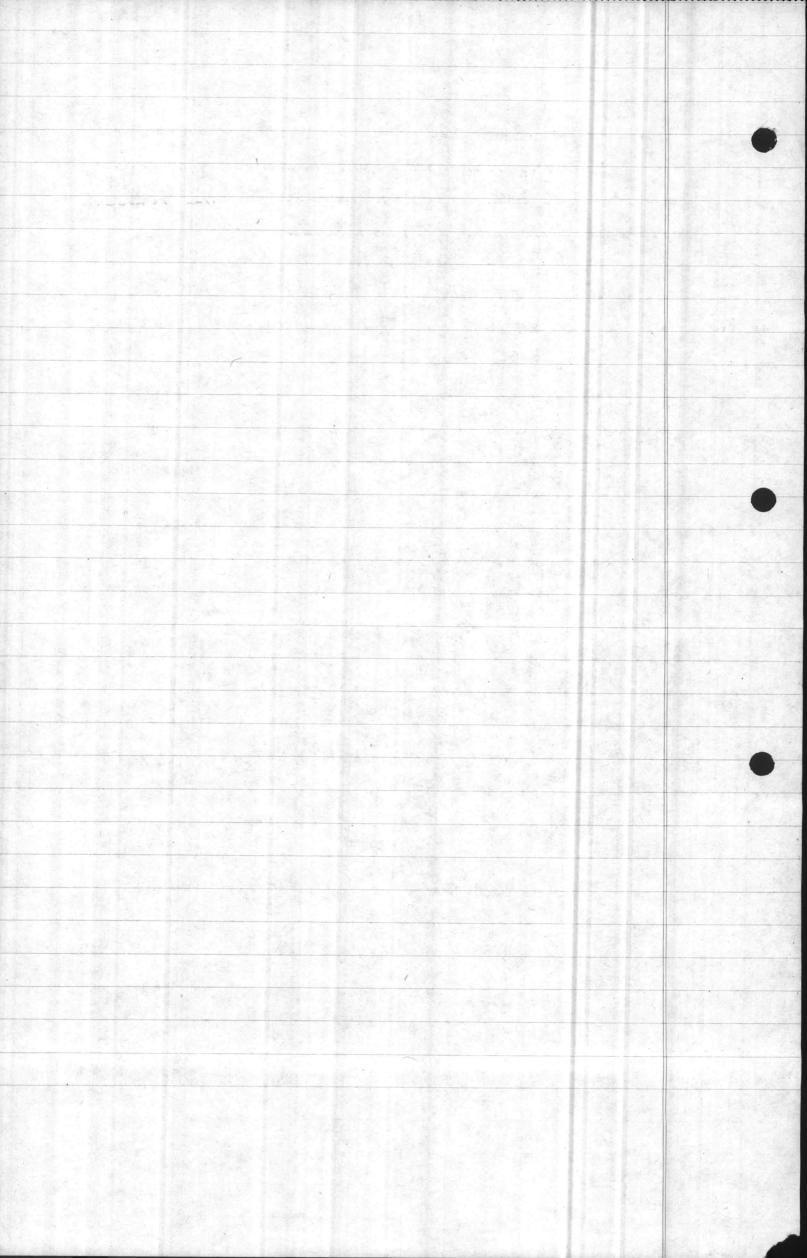

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P-501 The following areas were authorized to be mapped

	Tracing					
	Quadrangle No.	Ya D. No.	P.W. No.	Remarks		
	98	228,331	1			
	99	228, 332	2			
	100	228, 333	3	V		
	//8	228, 334	4	/		
	119	228, 335	5	V		
	120	228,336	6			
	139	228, 337	7	V		
	140	228,338	8			
	159	228, 339	, 9	~		
	160	228,340	10	V		
	179	228, 341	//			
	180	228,342	12			
	181	- 228,343	/ 3			
	198	228,344	14			
	199	228,345	15			
	217	228,346	16			
	218	228,347	17			
	219	228,348	18			
	220	228,349	19			
*	15.7	228,350	20	Not traced 11/20142		
	201	228,355	25	2		
	177	228,400	70			
	197 .	228,401	71			
	137	228,408	72	Mot travel 11/23/42		
	142	228, 409	73	- H H U		
	162	228,410	74	н р н		
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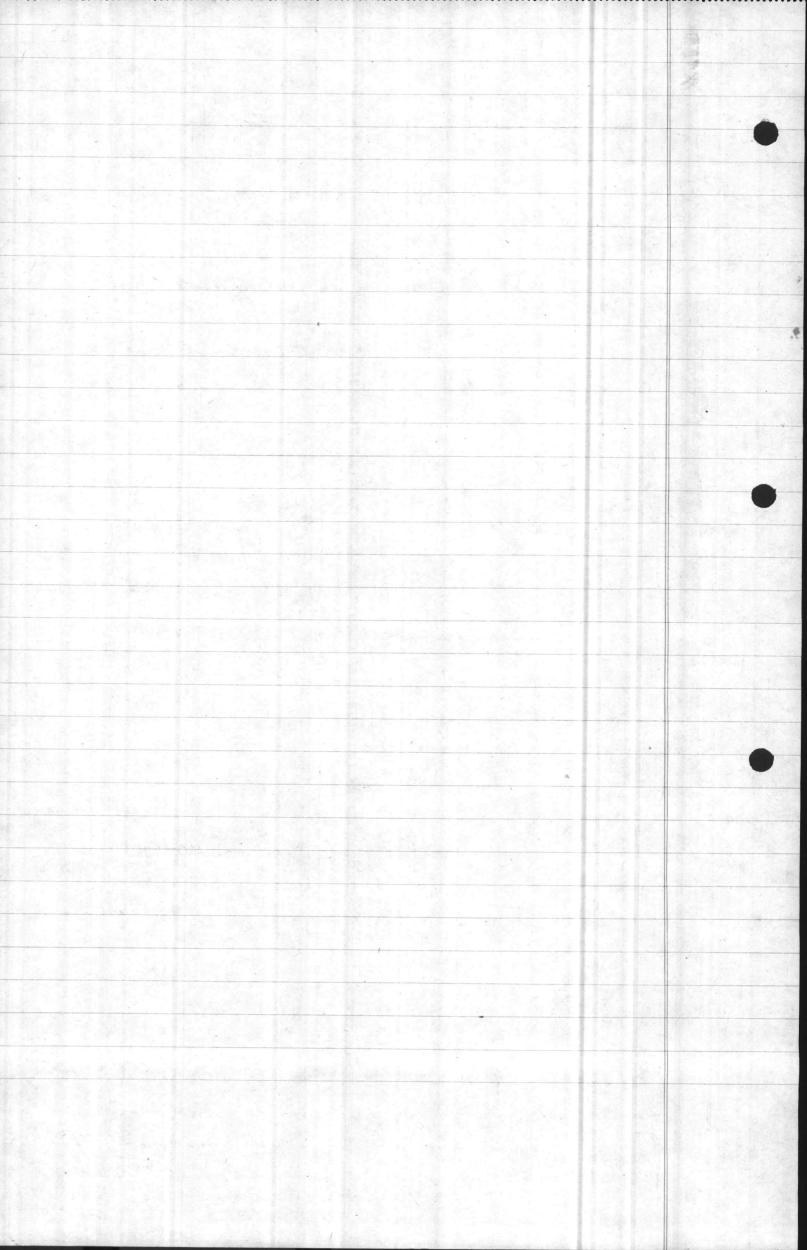


P-502 Accurate control was established for all 1=500' maps by means of triangulation to and by coordinated traverses. Monuments set on the reservation Expand? boundary or in areas not covered by 1"= 50 maps Certain, botted accurately a coordinates tabulated. Boundary ling courses and distances (were also) shown: (See pg 14 for addition to beginning of this ppg.) F-503 After the basic 500 scale maps were completed various departments of tracing cloth and the layout, resulting in small scale planning and operating maps showing respectively the distributing systems of the various ofilities. The utilities so mapped and P.W. Mos. assigned were as follows: P.W. No (Suffix to) Utility Electrical Distb. Heating, Mains of Plants Street Lighting, Circuits Sewerage Systems Communications Lines Water Collection of Distribution Propane Gas
(Thus tas sewerage map drawn on a reproduction of
0. w. Day, no 10 would be numbered P.W. (10-5)

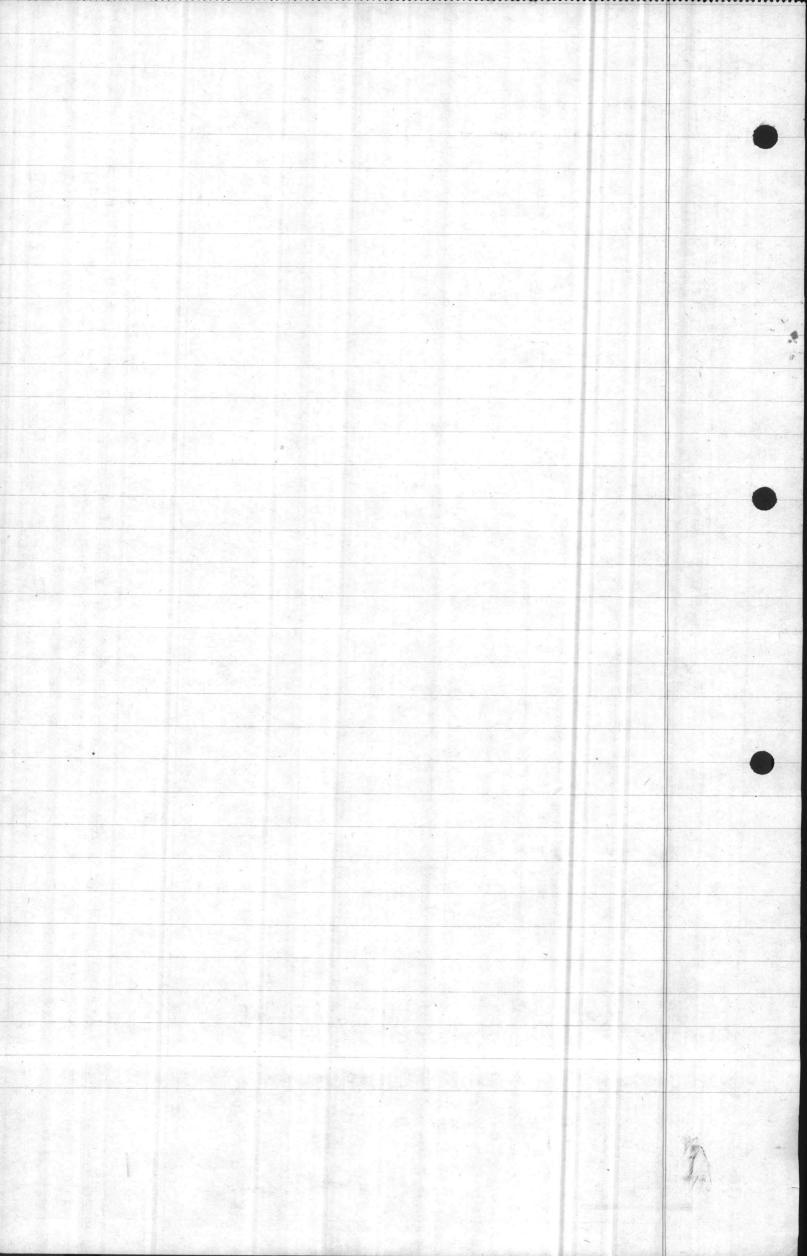Key maps prepared:

On 1 No Whilities thapped Utilities mapped Quad. No. P.W. No. E, H, L, S, T, W E, T, W E, L, S, T, W. E, S, W E, L, S, T, W 139 E, H, S, T, W 140 E, G, H, L, S, T, W

E, T



P-601 (See page 9)

P 602 The 50 scale maps constitute the basic final record of utilities and show the following data: Outlines of buildings and other structures

Cilverts and invert clovations

Water Mains, including values, Fire hydrants, tanks etc.

As built elevations where such info, was available

Sewers

Gas lines

Steam lines

Pole lines

Underground alectric & communication lines

Gasoline a fuel oil lines a pumps.

Permanent coordinated monoments and & sta,

Bench Marks

Threaways and pits

Storm drains

Railroad tracks, roads & sidewalles

P-603 A color scheme was selected to comply as closely with Bureau of Yards & Docks standard for operating maps as possible, diverging only where it was apparent that the standard color would not furnishe satisfactory photostatic reproduction. The final schame as set forth in Specification No. 1000 addendum No. 1 is as follows


Fresh Water - Blue Salt Water - Green

Steam Mains - Orange

Sewers - Black

Propane Gas - Carmine

Fuel Oil - Carmine

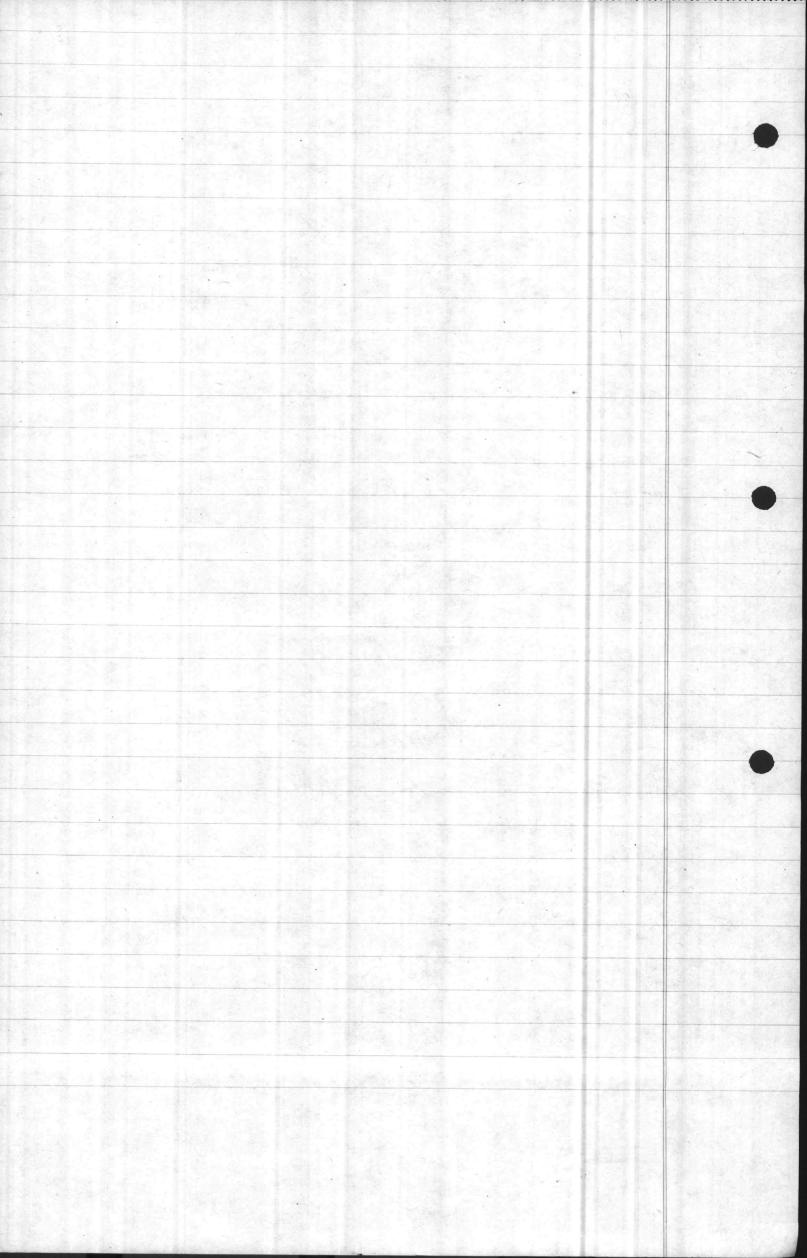

P-403 (continued)

Gasoline - Violet

Elect lines - Scarlet

Communications

Paved Roads a Sidewalles - Gray

P- 601_ 1"= 50' Scale Maps

This phase of the work was by far the

most extensive. The original authorization of this project, instruded by the Ole and shown on MB. Drawing April '42

No 1174, included only the Main Division Area, Industrial
Area & Tent Camps but was later, expanded by the

Commander Withings to twice the original assignment

Kos including the following areas: Amphibian Base &

Balloon Barrage School, Landing Field, Amphibian Base


Tent Camp, RiPle Range, Mumford Point Tent Camp and Officers Quarters Area. The last How to

extend from Wallace Creek to the northern limits


of construction on Paradice Point.

A Tabulation of the 1" 50' scale maps. follows.


3	11111	A management of the same of th	1 1 1
	Arca	Quadrangles	Remarks
	Mumford Point T.C.	99 U-18 U-Z	
	Many or the	U-3 & U-4,	
		A-3 & A-4	
	Amphibian Base	118 H-1 & H-Z	
	Tent Camp.	118 n-1 a n 2	
	.,,		

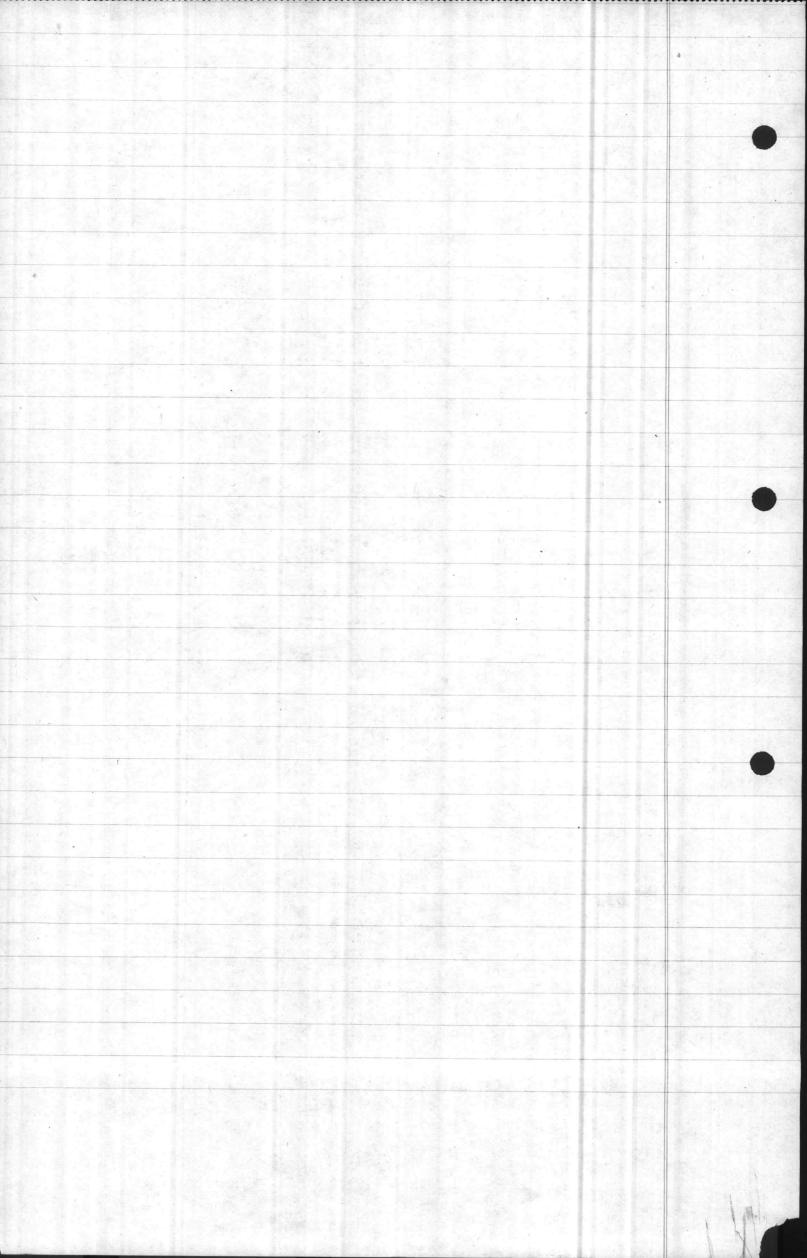


. 9	(1"200' tabulation continued)					
	Residentialarea					
0	(SPP - 1)	119	1-3 41-4			
			Q-1 & Q-2			
			Q-3 & Q-4			
			R-1 & R-2			
			R-3 & R-4			
			S-1 & 5-2			
			5-3 8 5-4			
			W-1 & W-2			
			X-1 8 X-2			
			X-3 8 X-4			
		139	D-1 & D-2			
			E3 & E-4			
			J-3 & J-4			
			0-180-2			
			0-380-4			
			T-1 & T-2			
	V V		T-3 8 T-4			
	To he had a		,			
	Rifle Range	198	Q-14 Q-2			
			Q-34 Q-4			
			V-1 & V-2			
			V-3 & V-4			
			W-3 & W-4			
		218	B-3 & B-4	2.5 (1985)		
			,,,,,,,,,,,,,,,,,,,,,,,,,,,,,,,,,,,,,,,			
	Balloon Barrage	219	D-18 D-2			
		2.1	EIR E-Z			
	As Amph.		E3 & E-4			
	Base		I-1 & I-2			
				V		
			J-1 & J-2			
			J-3 & J-4			
			0-1 8 0-2			
1		W = -	0-3 2 0-4			
had to		220	F-3 8 F-4 K-3 8 K-4			
		and the second	n a a a a f			

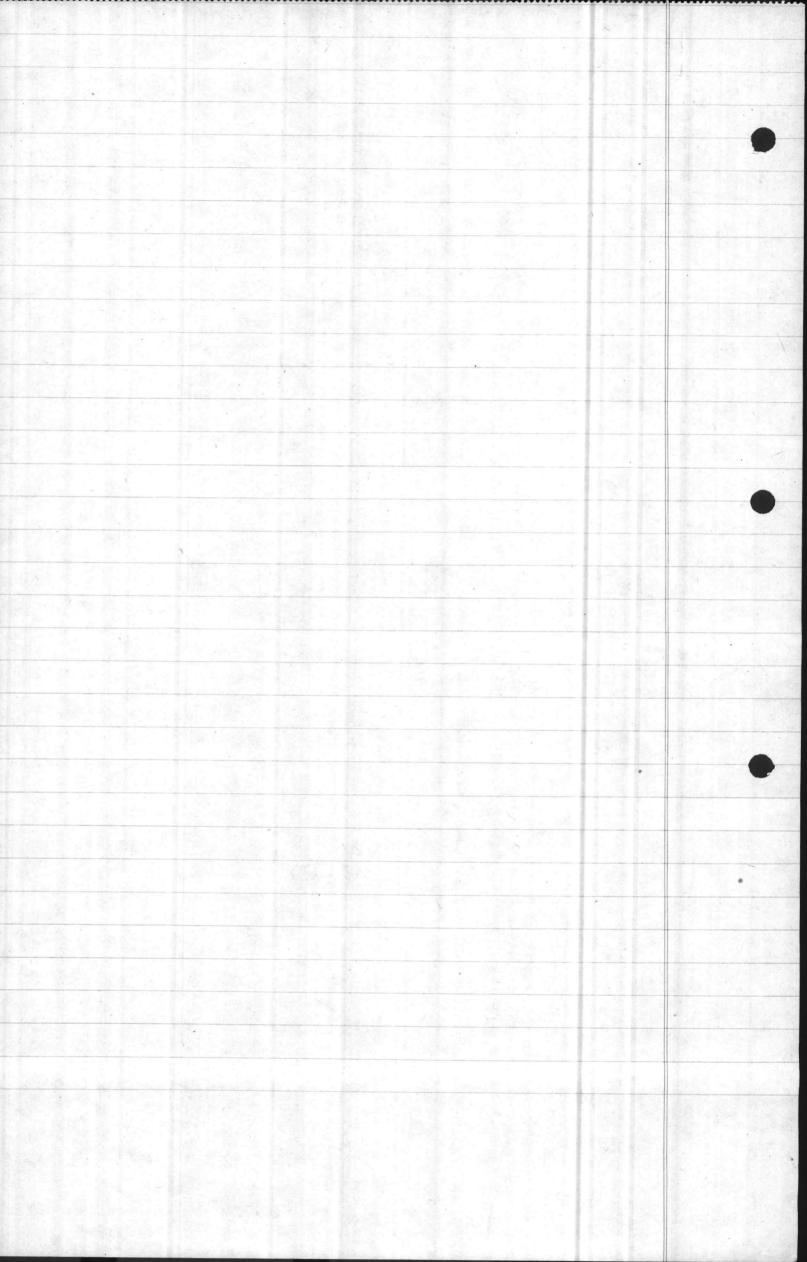

					(I)
(D)	(1=50'30	cate n	nap tabulation o	entinved)	
	Fint Camp 182	98			
43			K-3 & K-4		
_			P-1 & P-2		
			P-3 a P-4		
			Q-3 a Q-4		
			U-1 & U-Z		
			U-3 & U-4		
		118	A-18 A-2		
			7-3 4 A-4		
	Hospital Airea	139	X-18 X-2		
	, mospilar lirea	101	X-3 & X-4	,	
			Y-1 & Y-2		
			Y-121 7-2 Y-3 8 Y-4	1	
			7-387-4	50	
		1.10			
	[Soft Industrial	140	하게 하는 아이들이 느낌을 하다면서 하는 데요요요요요		
	Arcea.		W-38W-4		
		160	C-1 # C-2		
			C-3 & C-4		
		le de la constant	B-18 B-2		
			G-1 a G-2		
			H-3 & H-4		
	Bldg				
	Parachule Tours	140	R-34R-4		
	Regimental Area	140	P-3 & P-4	9 9	
			D-18 U-Z		
			U-34 U-4		
			E-1 & E-2		
			A-18.A-Z		
			A-3 & A-4		
		1987	B-3 & B-4		. hydi
•			F-ld F-z		
			F-3 & F-4	1000	
			4 3 4 4 7		

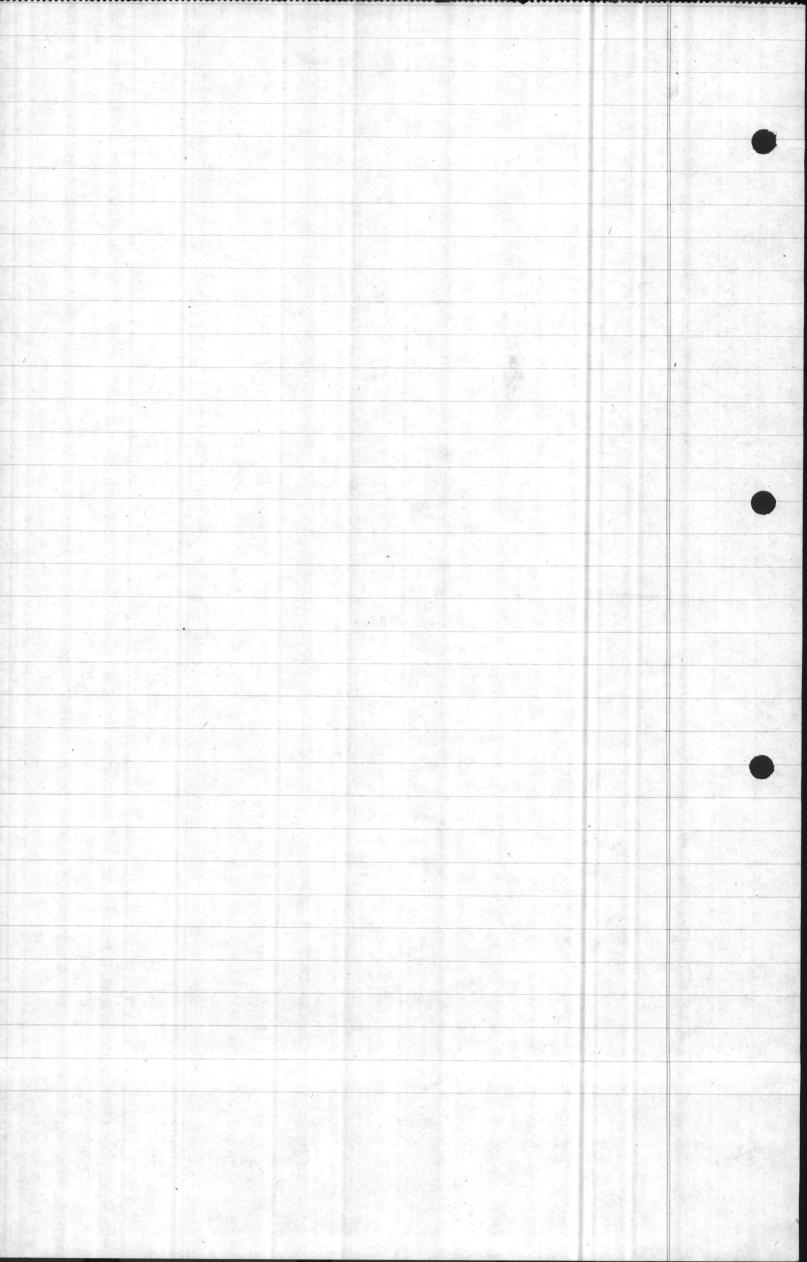

(U).	(1"= 50' maj	b tabulation continued).	(2)
	Reg. Area. (cont.)	160 K-1 & K-2	
		K-3 4 K-4	
		L-1 & L-2.	
		L-3 & L-4 ·	
		M-34 M-4	
		Q-1 & Q-2	
		Q-3 1 Q-4:	
		V-1 & V-2	
	Landing Field	118 R-1 & R-2	
		R-3 & R-4	
		S-3 & S-4	
		Tot	/a/ 79
			5. 2. 100

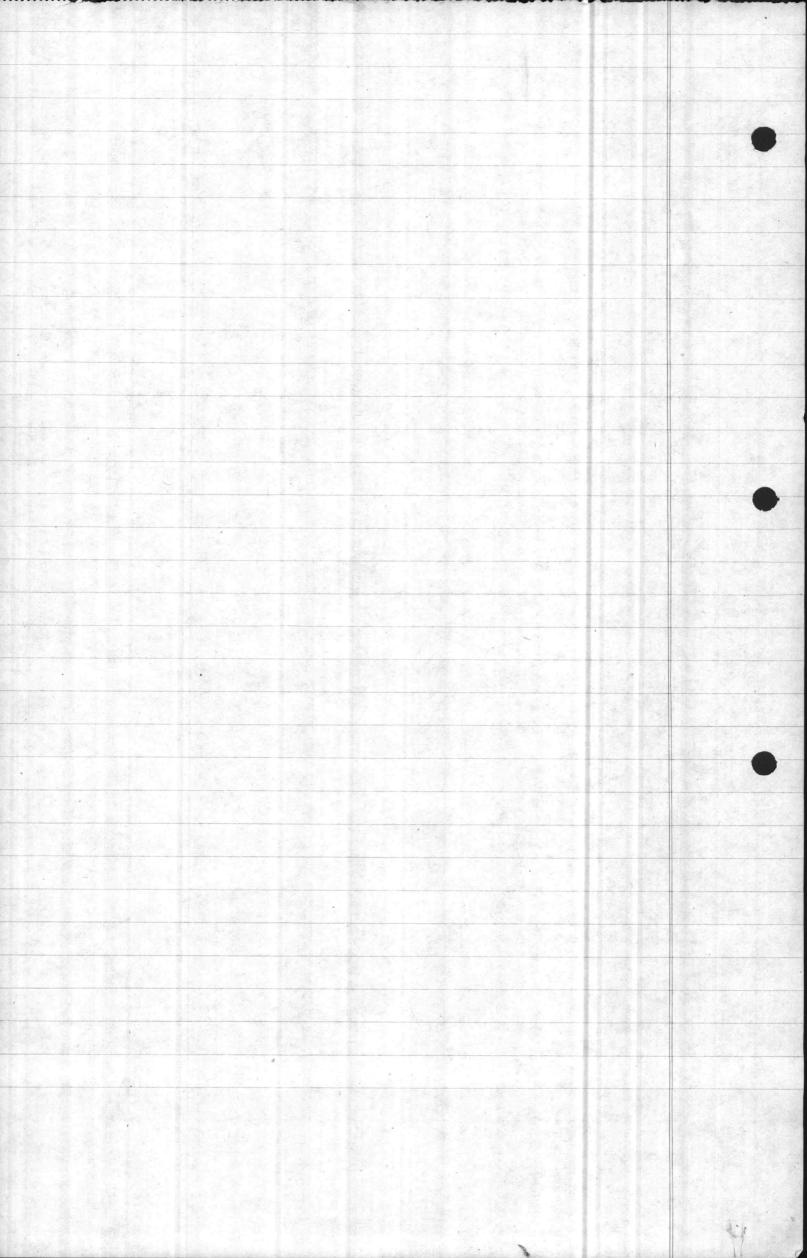

Section P-8

P.-502 (beginning)

The original drawing at 1" 500' covers an area 20,000 morth and south by 15,000' cost and west, of contains the following data:

Building oulline

B 1/1.

Building numbering plan

Road right of way lines & names

Railroads

Natural features

Triangulation net.

New River channel, markers, and lights

