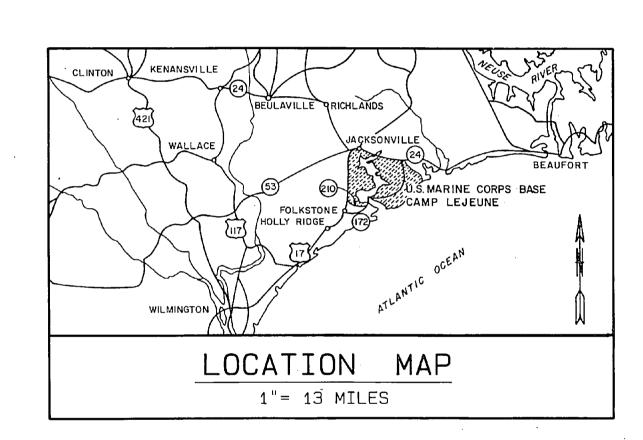
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SYM.	DESCRIPTION	BAYE	APPROYED					

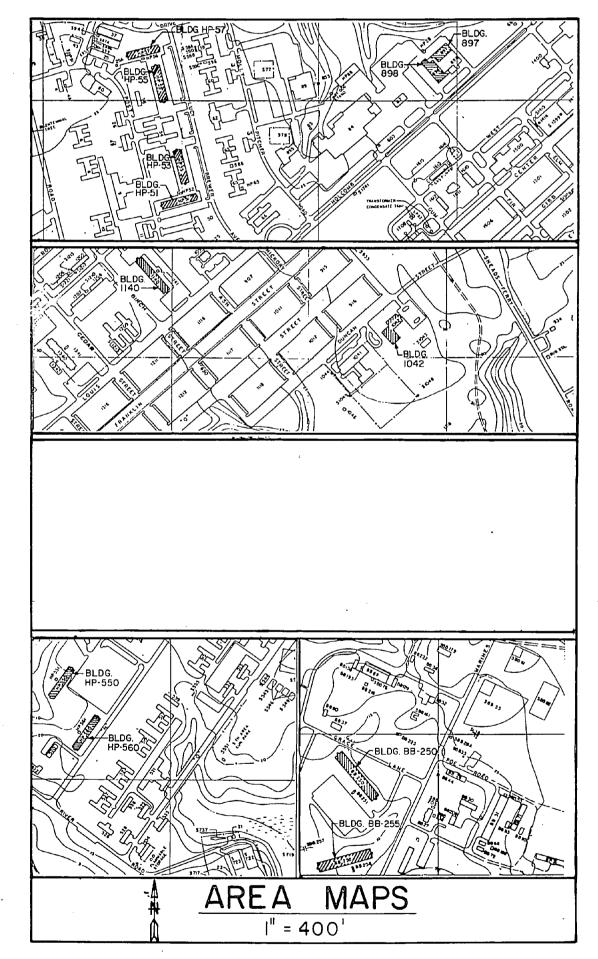
DEHUMIDIFICATION HADNOT POINT - CHB

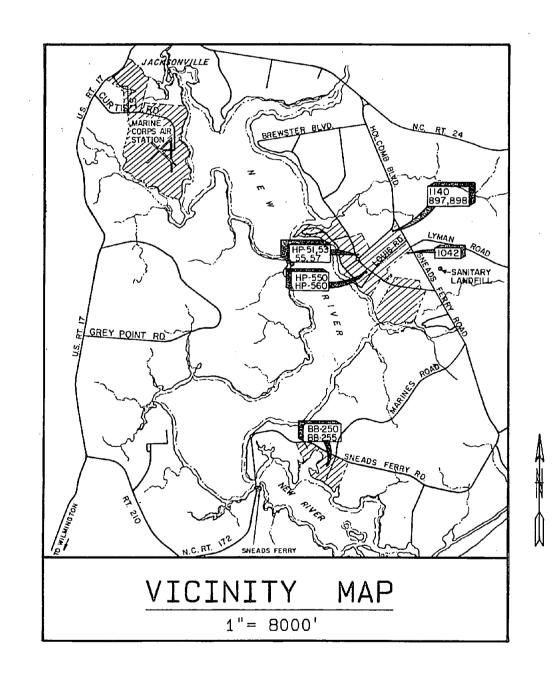
MARINE CORPS BASE

CAMP LEJEUNE, NORTH CAROLINA



		SCHEDULE OF DRAWINGS
DWG.	NAVFAC DWG. NO.	SHEET TITLE
C-1	4160837	COVER SHEET
M-1	4160838	HVAC ROOF PLANS, BLDGS. HP-51, HP-53, HP-55, HP-57 & 1140
M-2	4160839	HVAC FLOOR PLAN, BLDG. 1042
Е-м	4160840	HVAC 1ST. & 2ND. FLOOR PLANS, BLDG.897
M-4.	4160841	HVAC 1ST. & 2ND. FLOOR PLANS, BLDG.898
M-5·	4160842	HVAC ROOF PLANS, BLDGS. 897 & 898
M-6	4160843	HVAC DEMOLITION FLOOR PLANS, BLDGS. HP-550 & HP-560
M-7	4160844	HVAC NEW WORK FLOOR PLANS, BLDGS. HP-550 & HP-560 .
м-8	4160845	HVAC ROOF PLANS, BLDGS. HP-550 & HP-560
M-9	4160846	HVAC 1ST., 2ND. & 3RD. FLOOR PLANS, BLDGS. BB-250 & BB-255
M-10	4160847	HVAC ROOF PLANS, BLDGS. BB-250 & BB-255
M-11	4160848	HVAC DETAILS
E-1	4150849	ELECTRICAL FLOOR & ROOF PLANS, BLDGS. HP-51, HP-53, HP-55, HP-57 & 1140
E-5	4160850	ELECTRICAL FLOOR PLANS, BLDGS. 897, 898 & 1042
E-3:	4160851	ELECTRICAL ROOF PLANS, BLOGS. BB-250, BB-255, HP-550 & HP-560



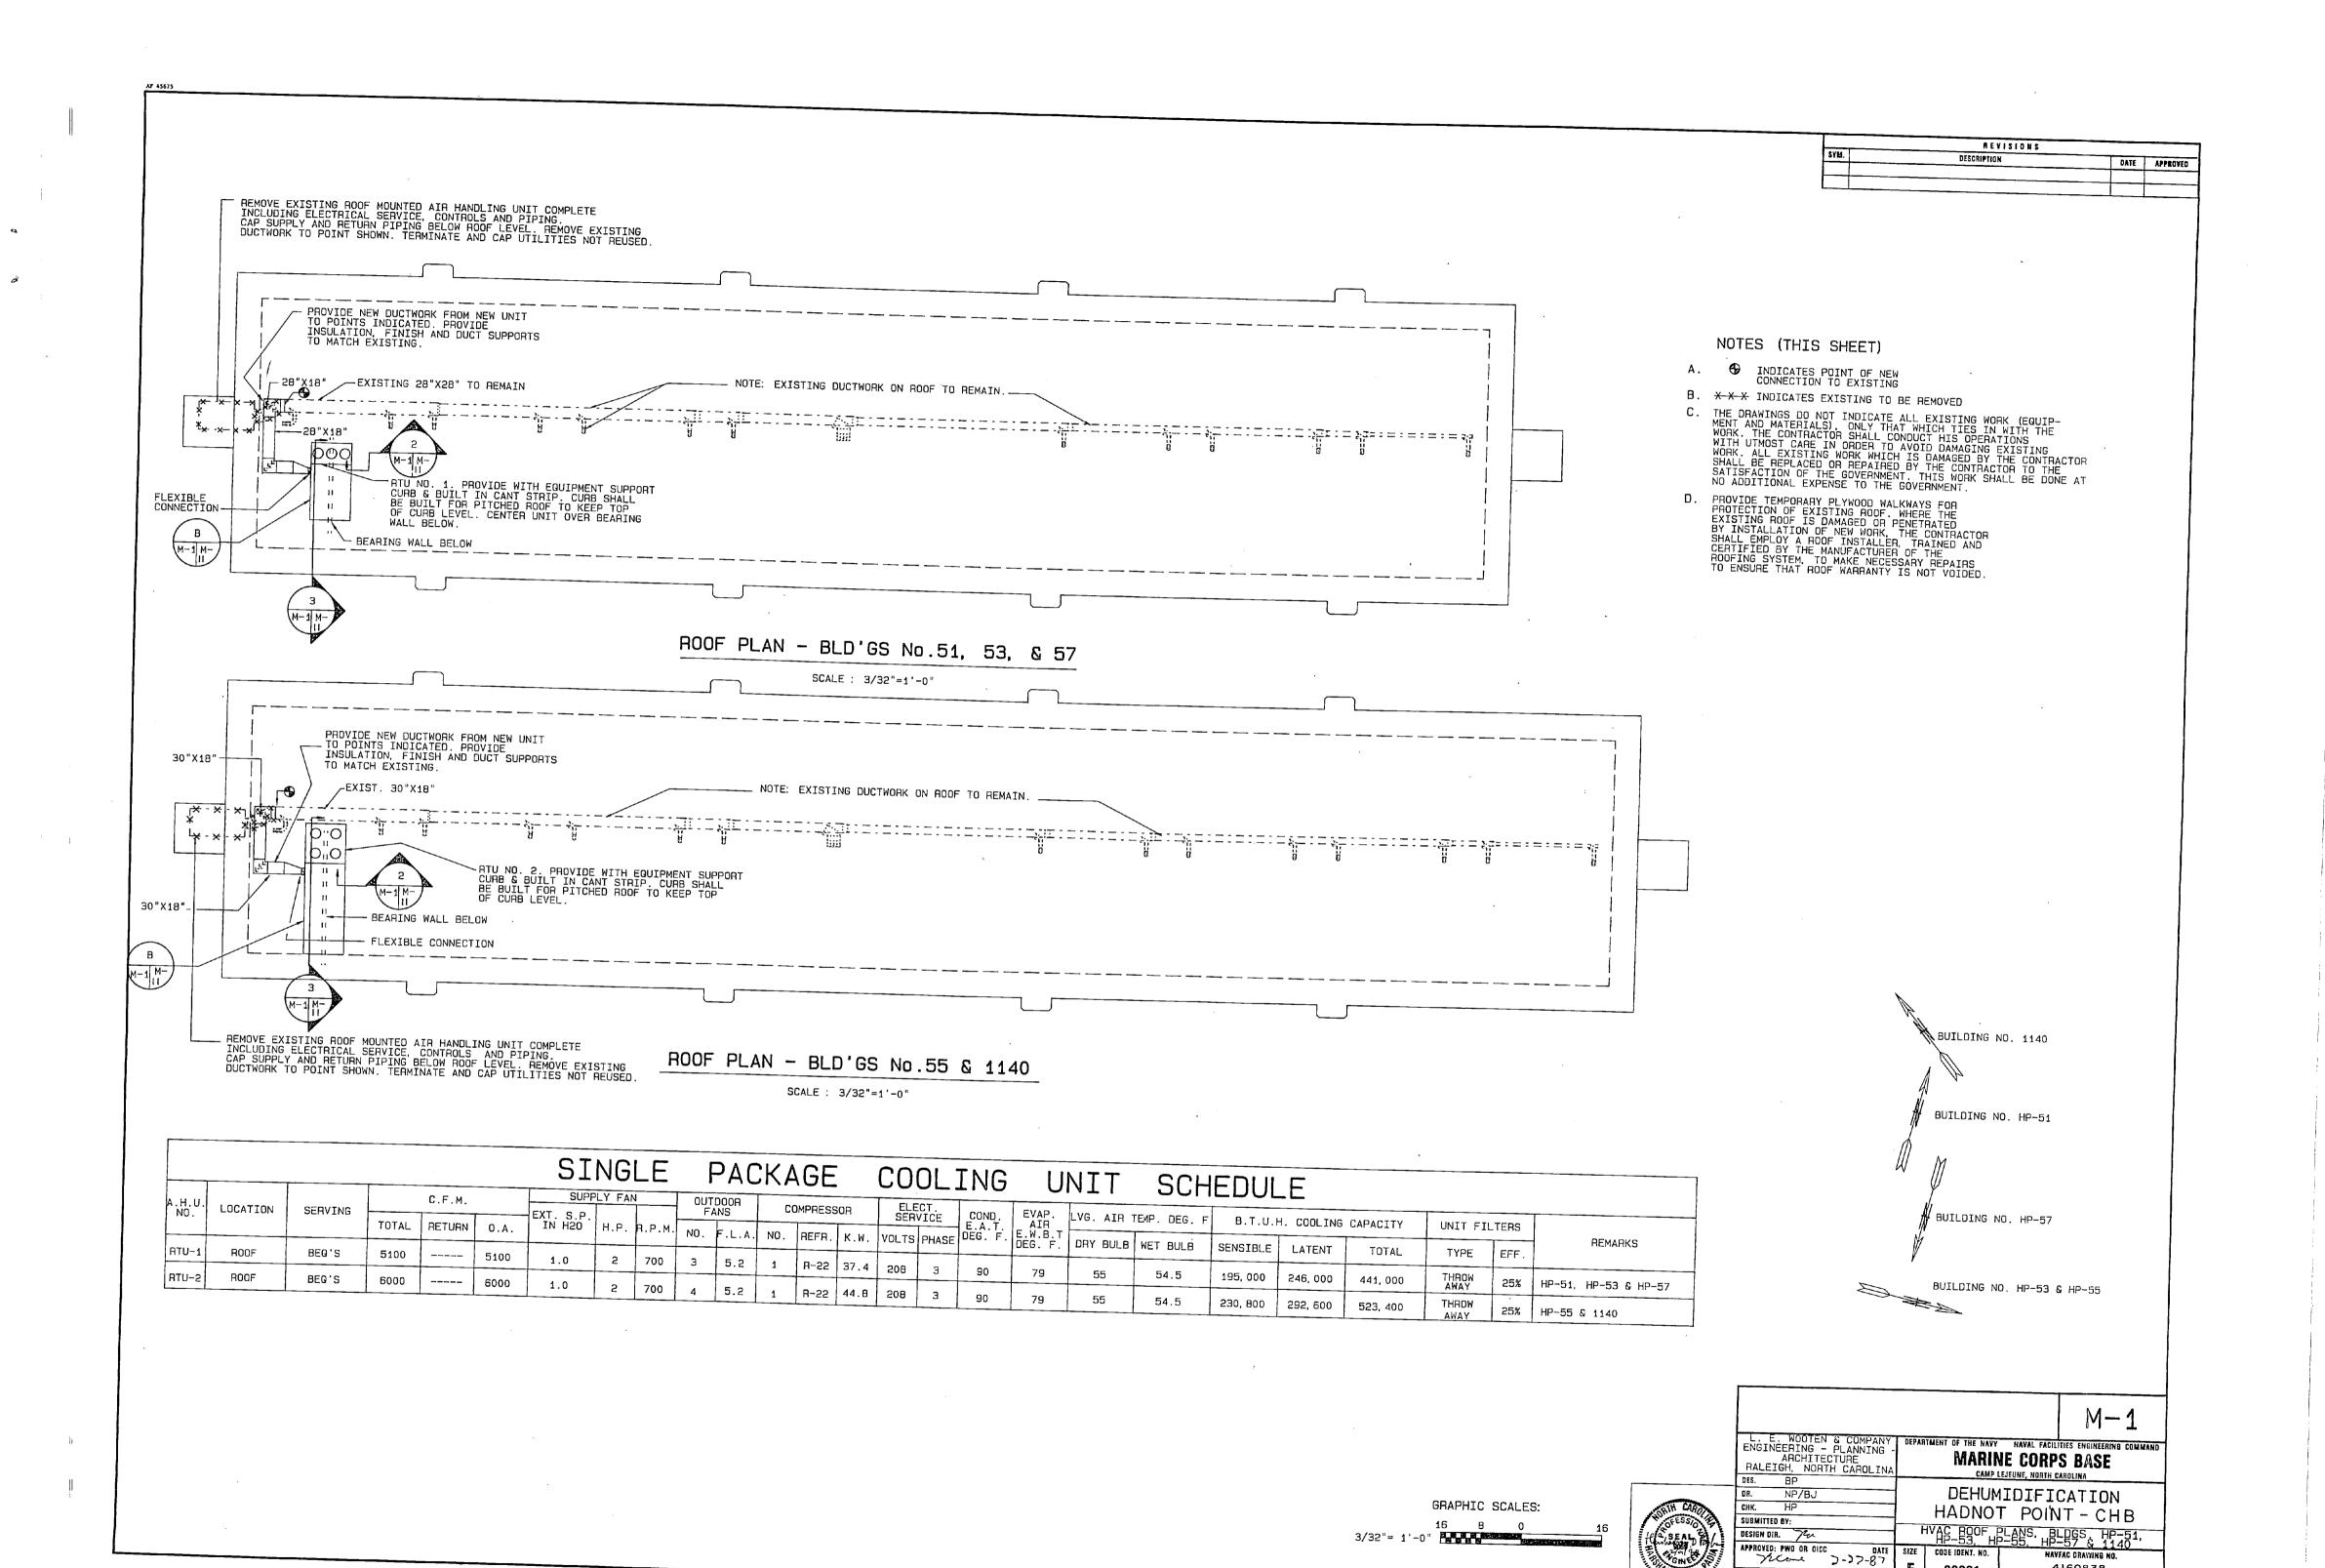


		GRAPHIC	SCALES:		
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1" = 400'	2001		600'	800'	1000'

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		RALEIGH, NORTH CAROLINA			CAMP	LEJEUNE, NORTH CAROLINI	A	_	
		ENGINEERING - PLANNING - ARCHITECTURE		M	ARIN	IE CORPS B	ASE		
		L. E. WOOTEN & COMPANY	DEPART	MENT OF T				COI	MMA

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HAVFAC DRAVVING NO. 4160838

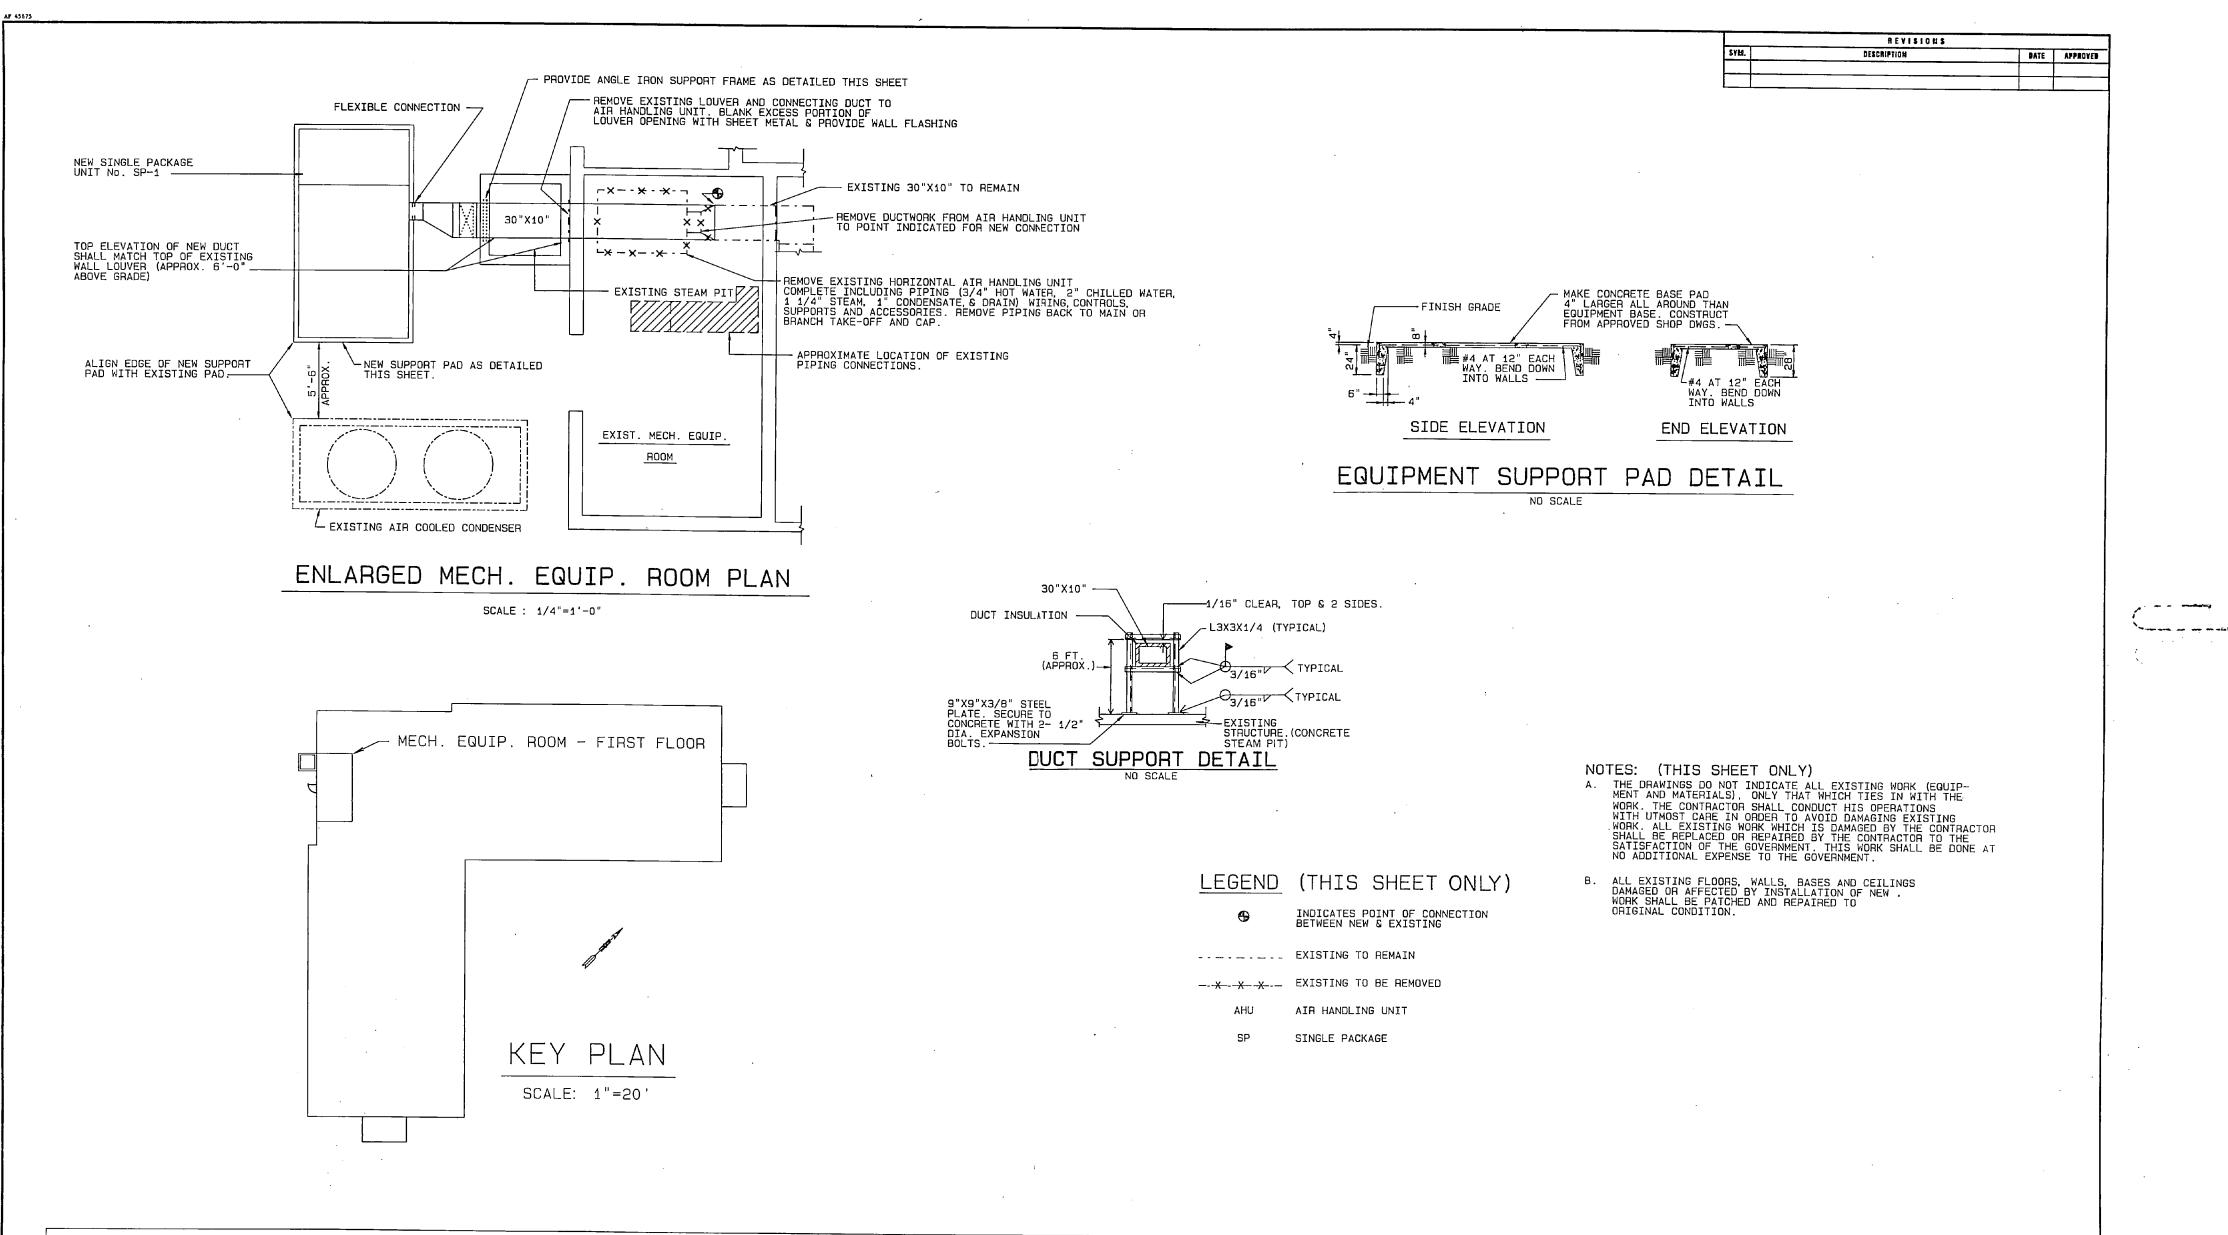
CONSTR. CONTR. NO. N62470-87-8-988

SCALE: HOTED SPEC. 05-87-9885 SHEET 2 OF 15

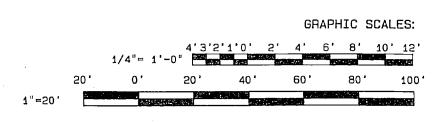
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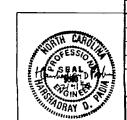
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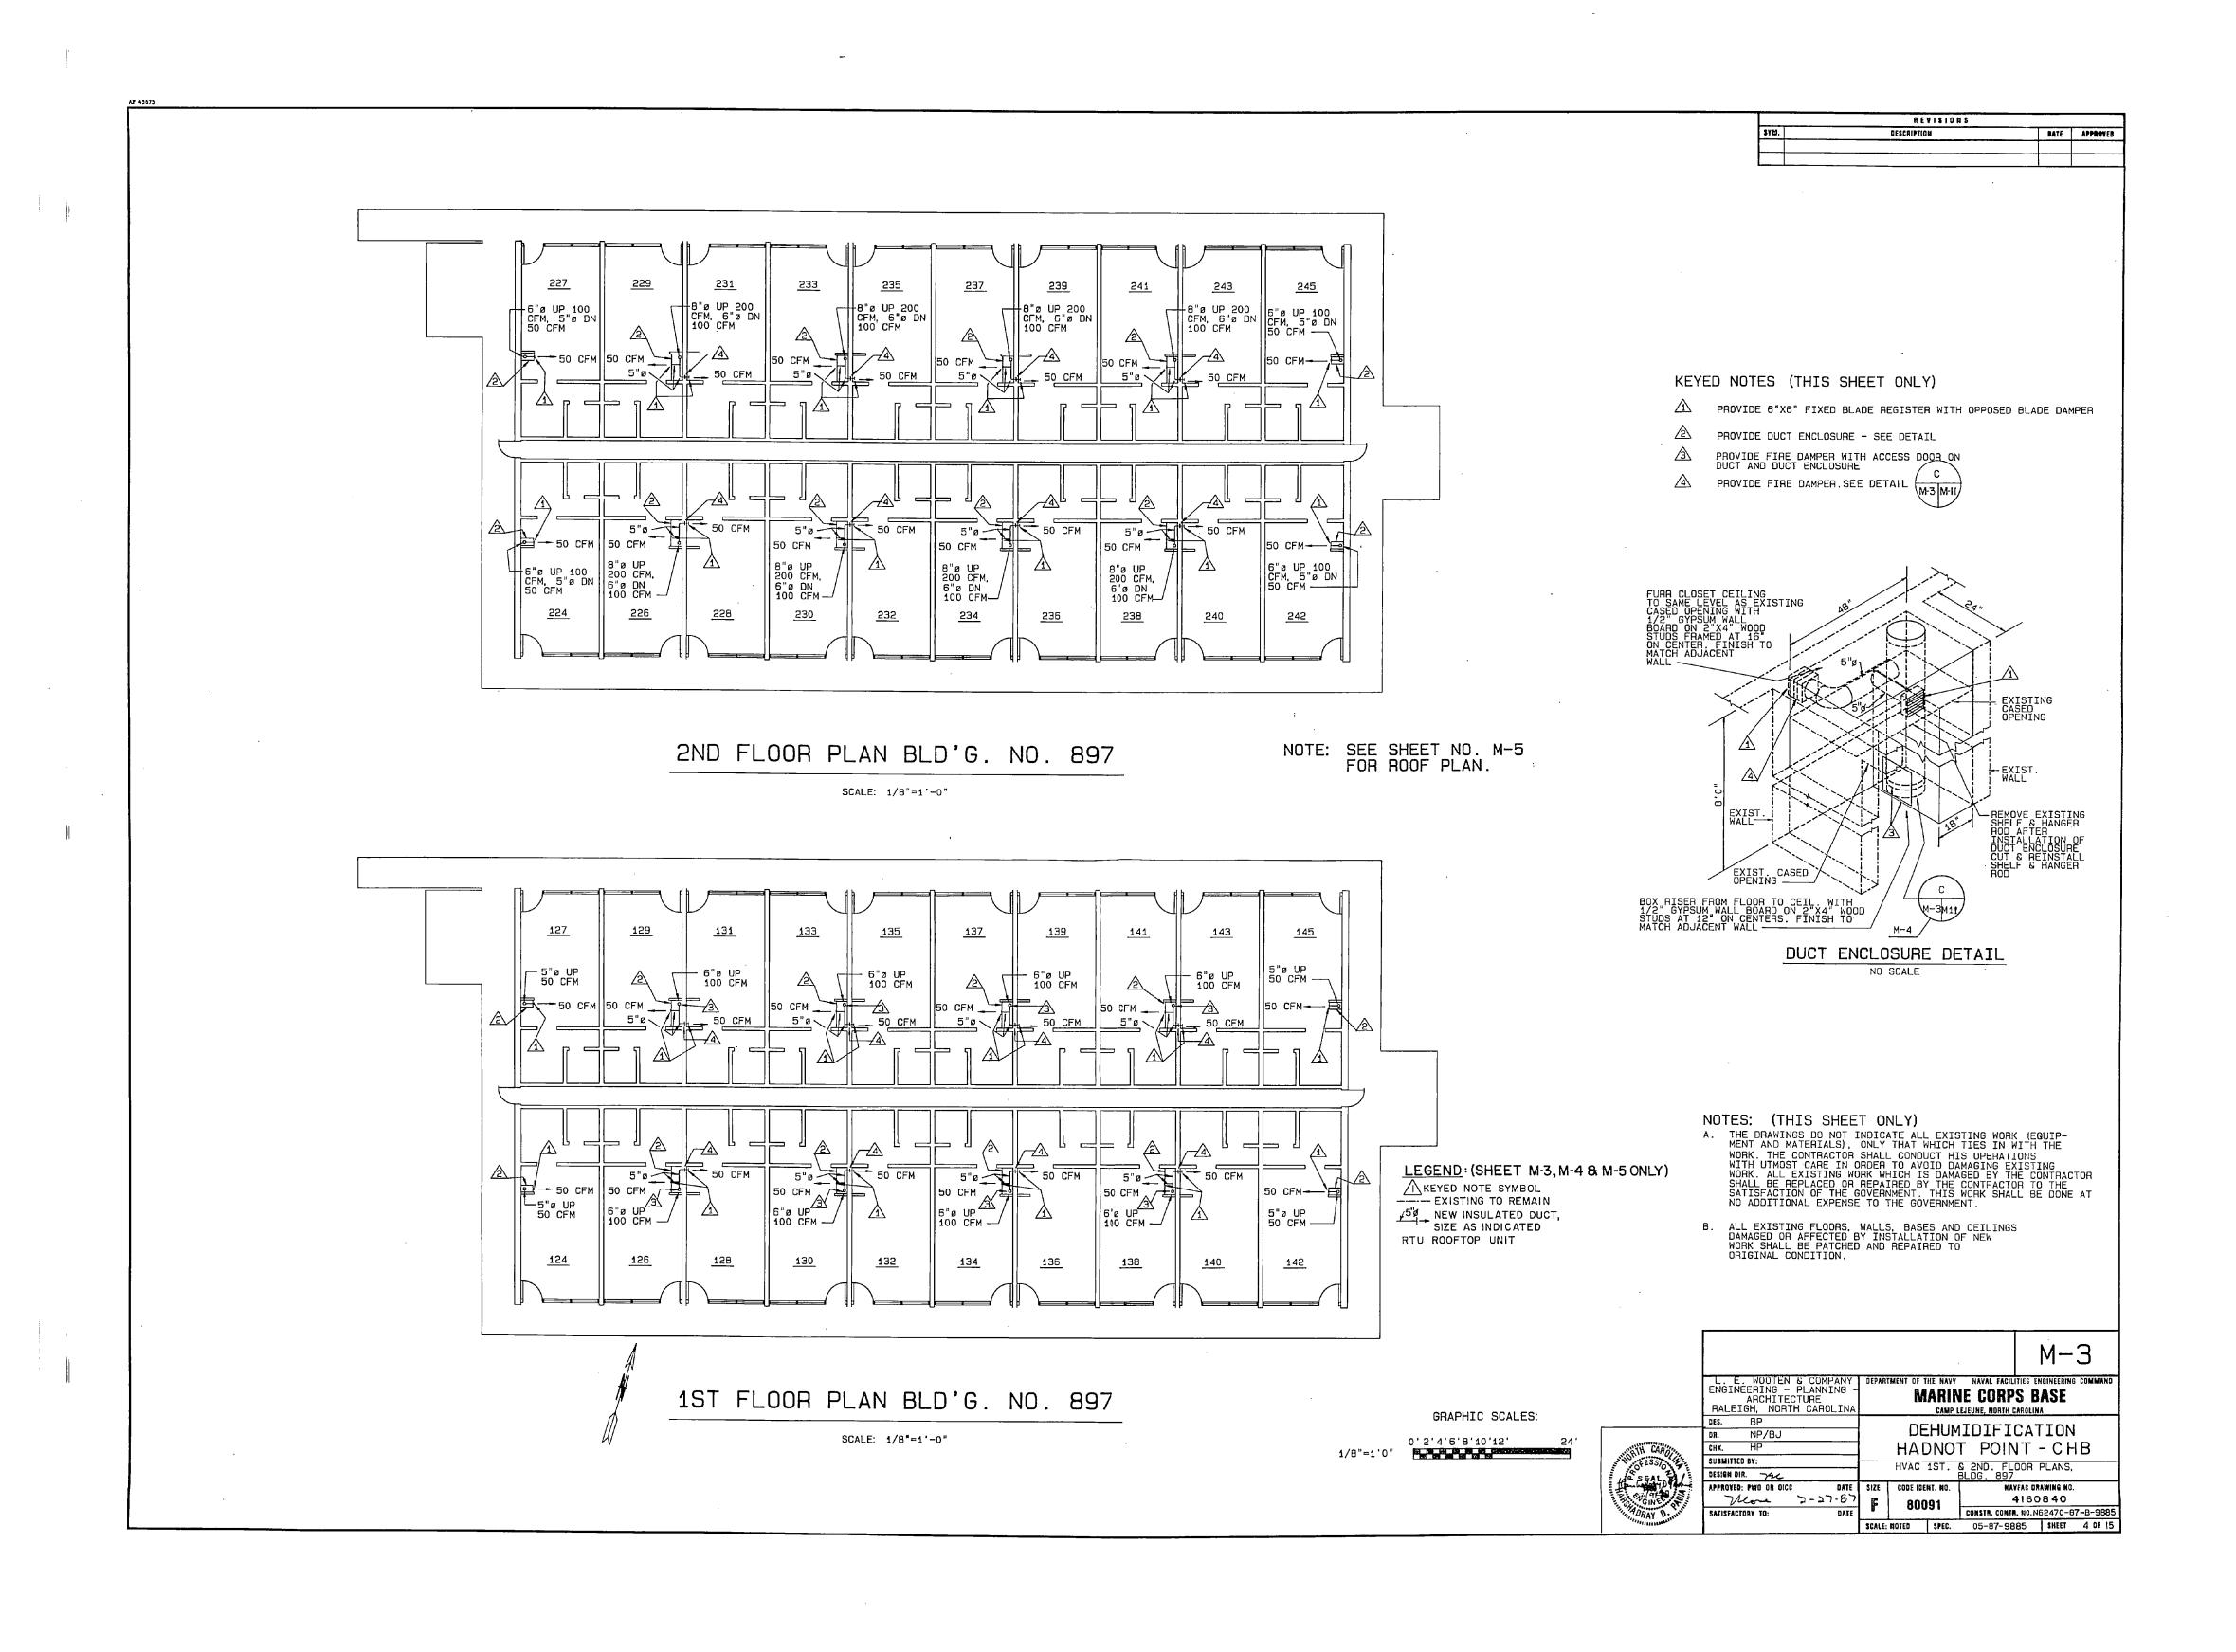
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110.			TOTAL	RETURN	D.A.	IN H20	Н.Р.	R.P.M.	NO.	F.L.A.	NO.	REFR.	K.W.	VOLTS	PHASE	DEG. F.	E.W.B.T DEG. F.	DRY BULE	WET BULB	SENSIBLE	LATENT	TOTAL	TYPE	EFF.	REMARKS
SP-1	PAD MTD.	BEG'S	2420		2420	.70	1	630	2	5.2	1	55	17.2	208	3	90	79	55	54.5	94, 200	119,000	213, 200	THROW AWAY	25%	



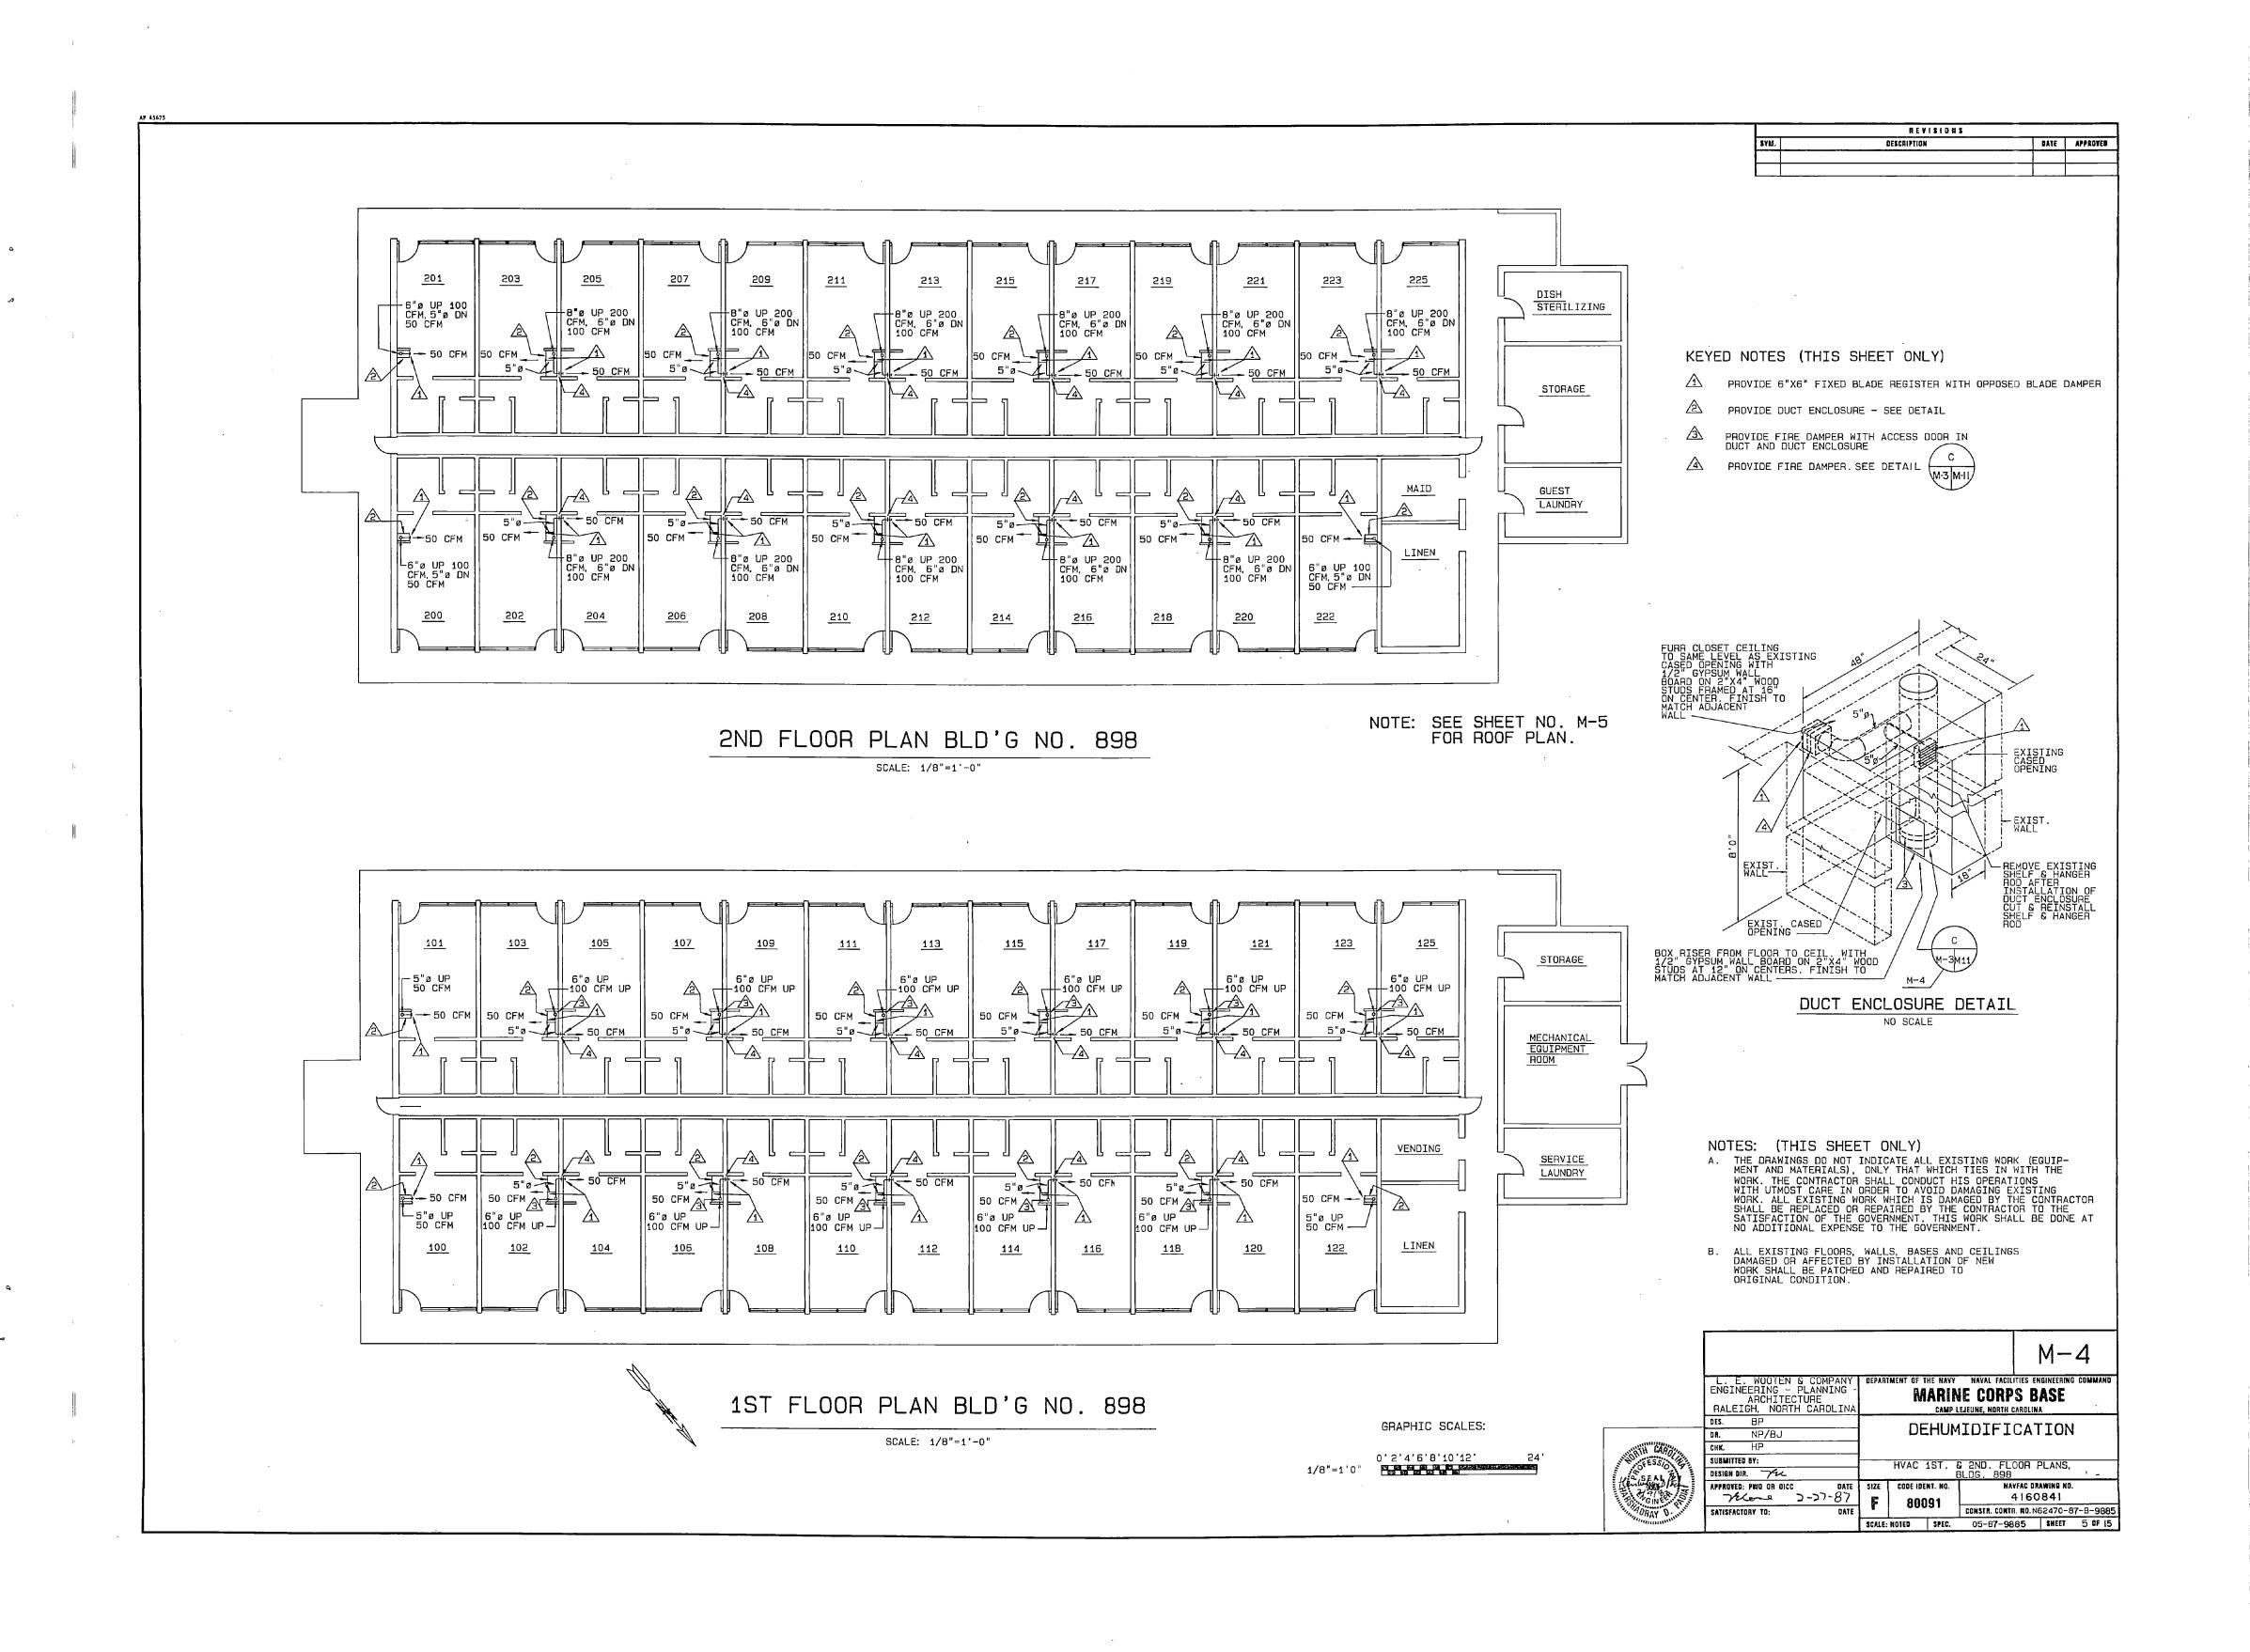


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	L. E. WOOTEN & COMPAN ENGINEERING – PLANNING ARCHITECTURE RALEIGH, NORTH CAROLI	; -	RTMENT OF 1	ARIN	NAVAL FACILIT IE CORPS EJEUNE, HORTH C		IG COMMAND	
è.	DES. BP DR. NP/BJ CHK. HP SUBMITTED BY:			ONO.	IDIFIC T POIN	T - CI		
35	DESIGN DIR. THE		HVAC FLOOR PLAN, BLDG. 1042					
No.	APPROVED: PWO OR OICC DATE		CODE IDE			FAC DRAWING N	D	
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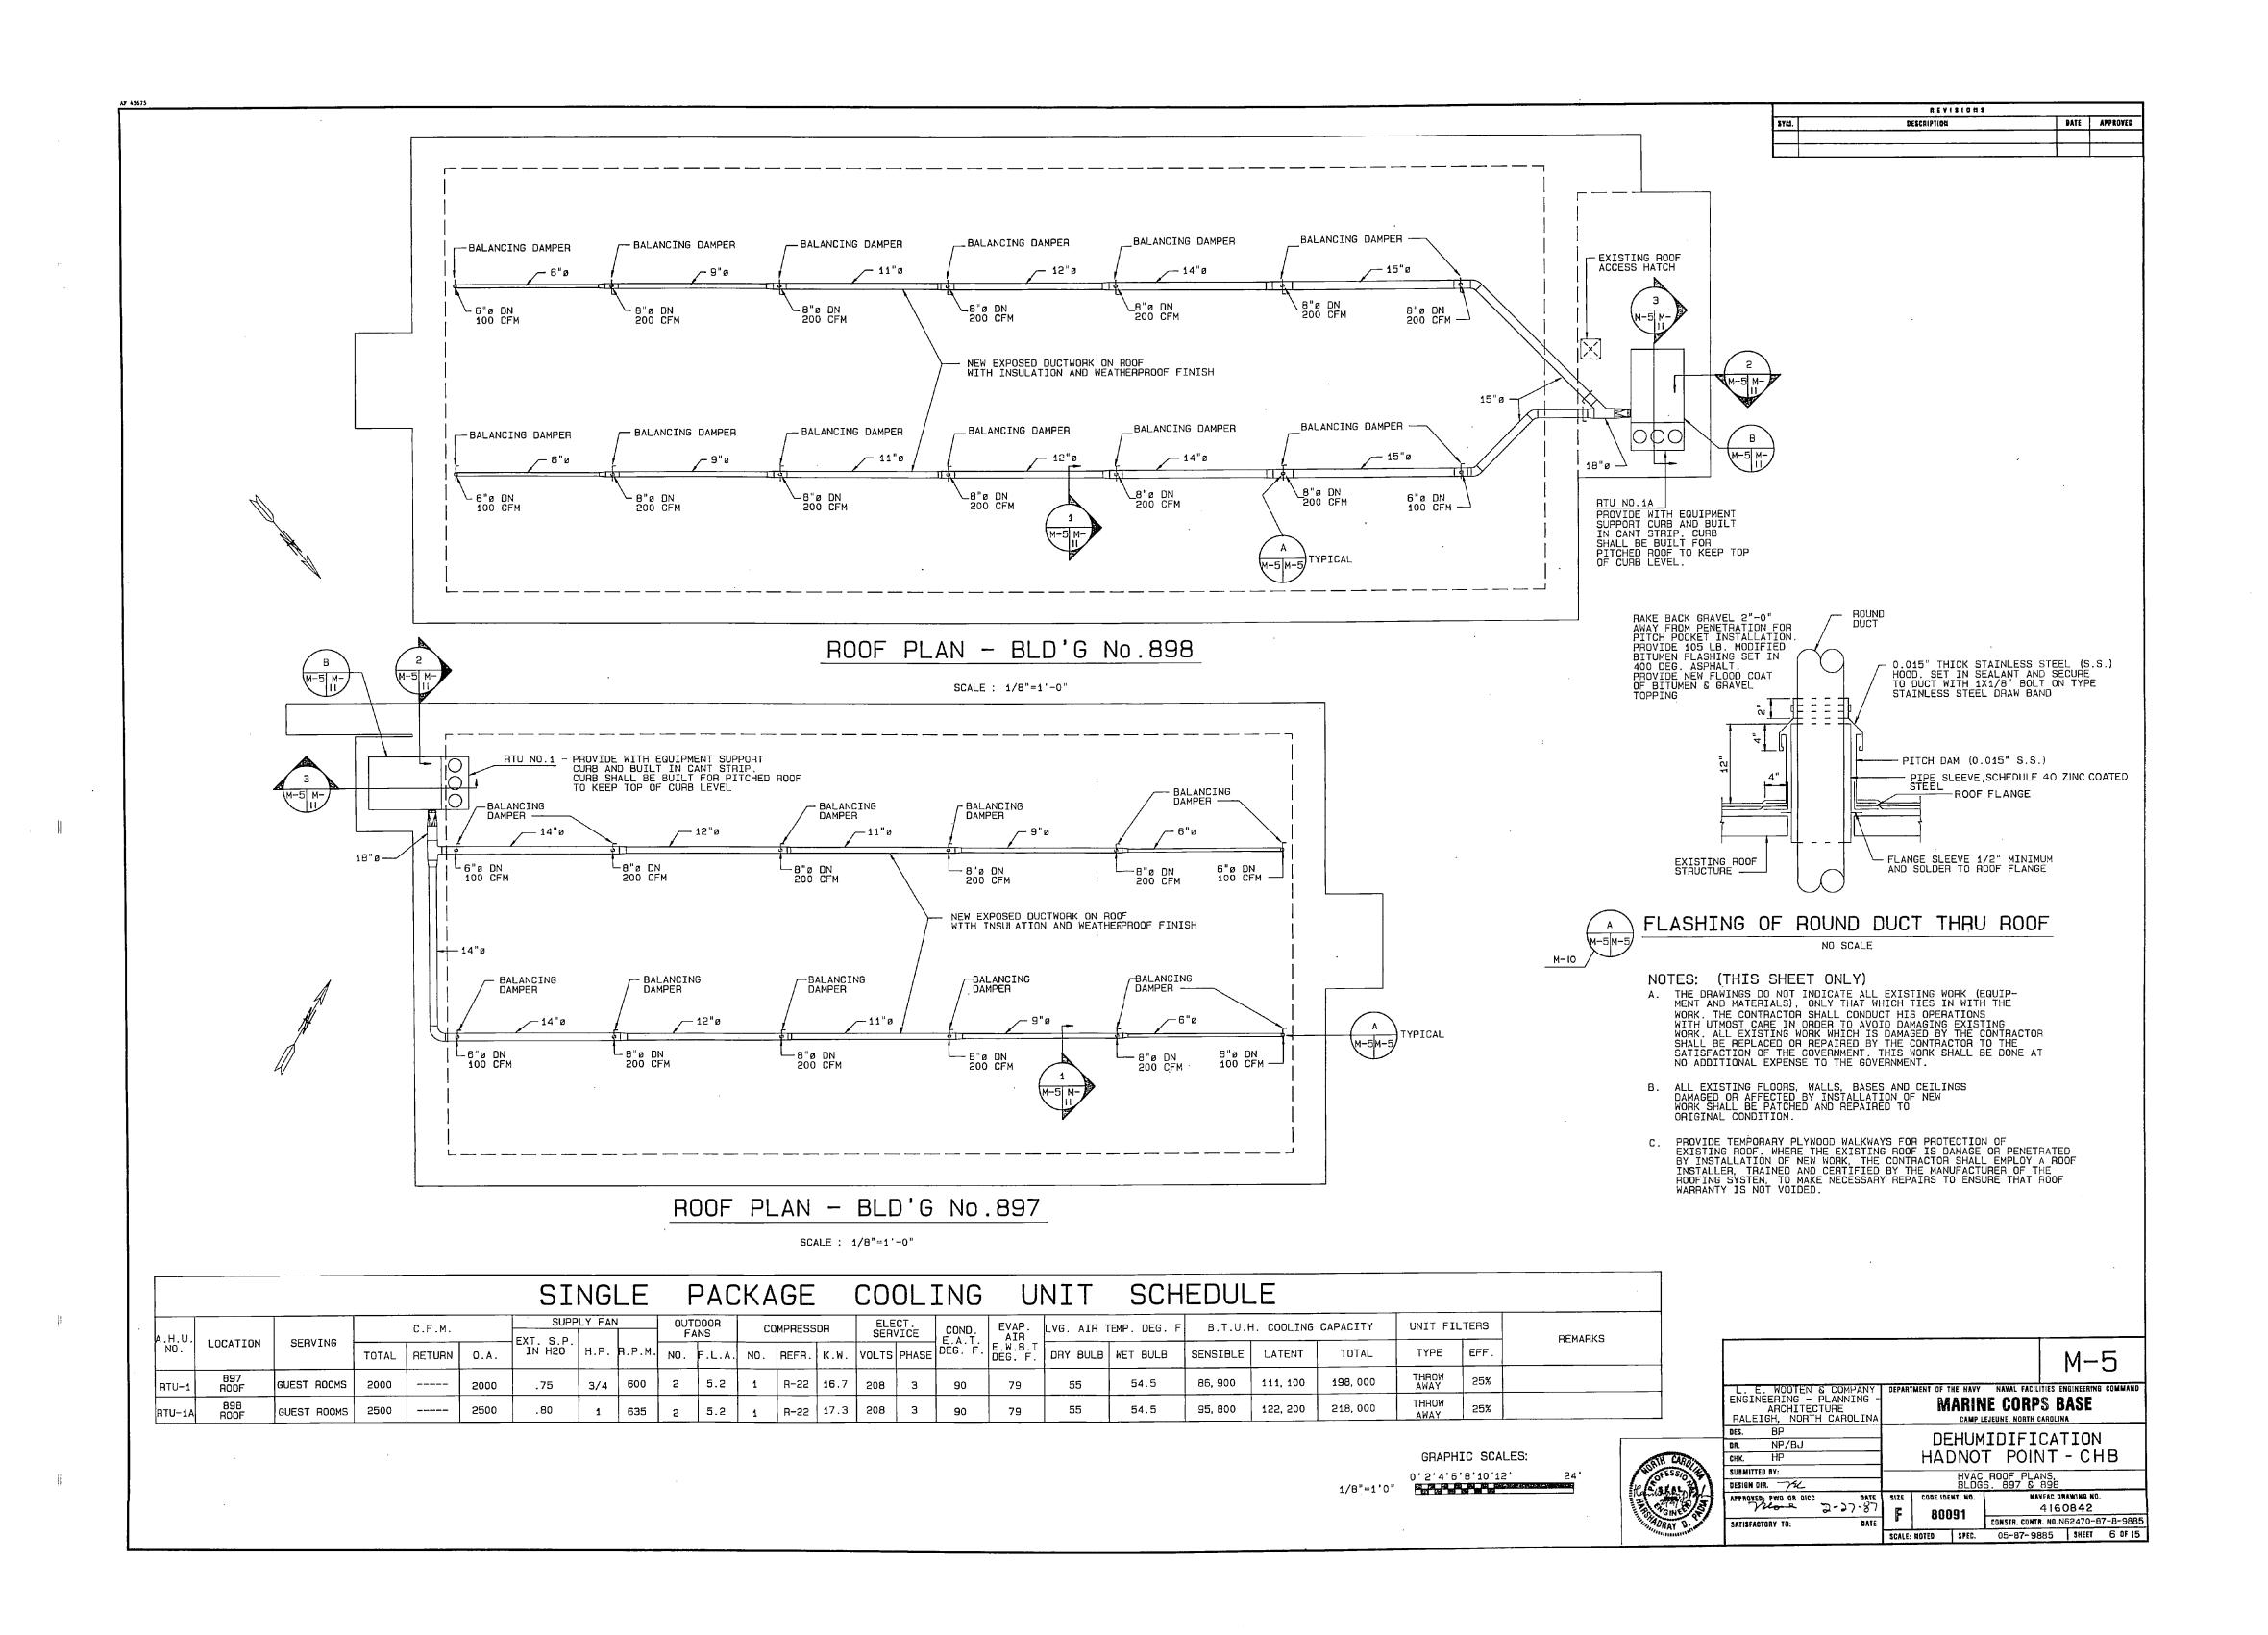
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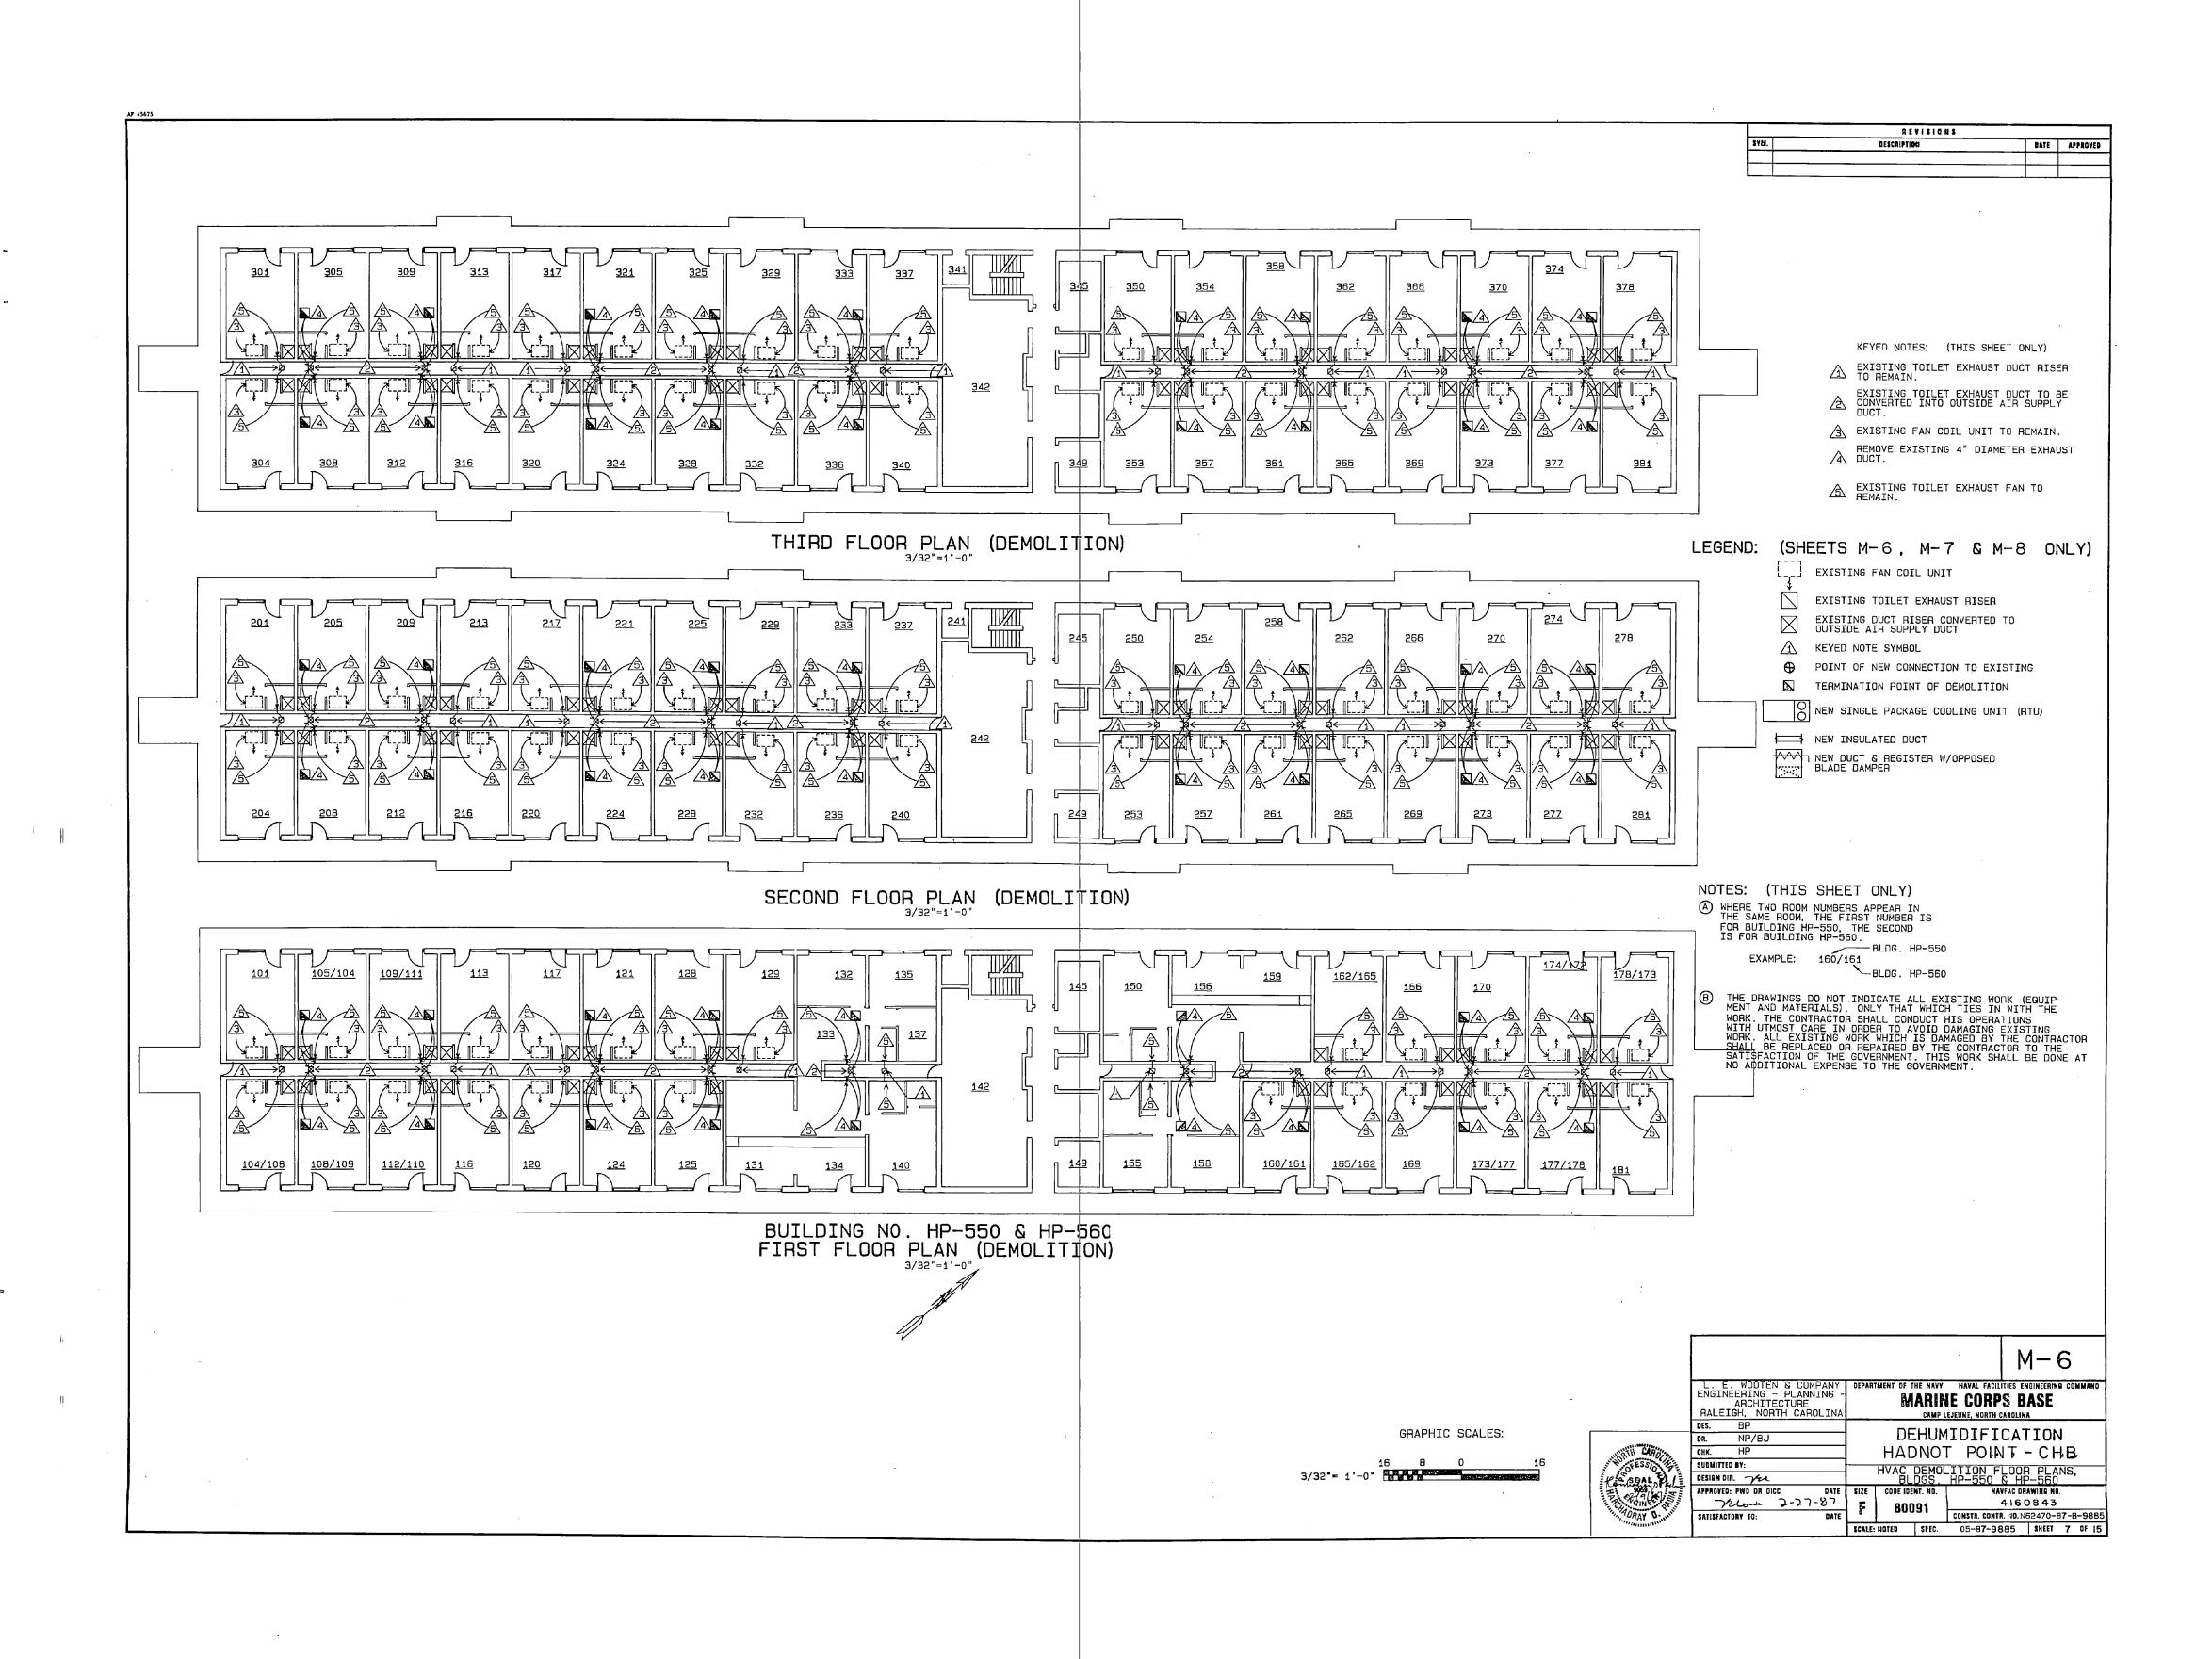
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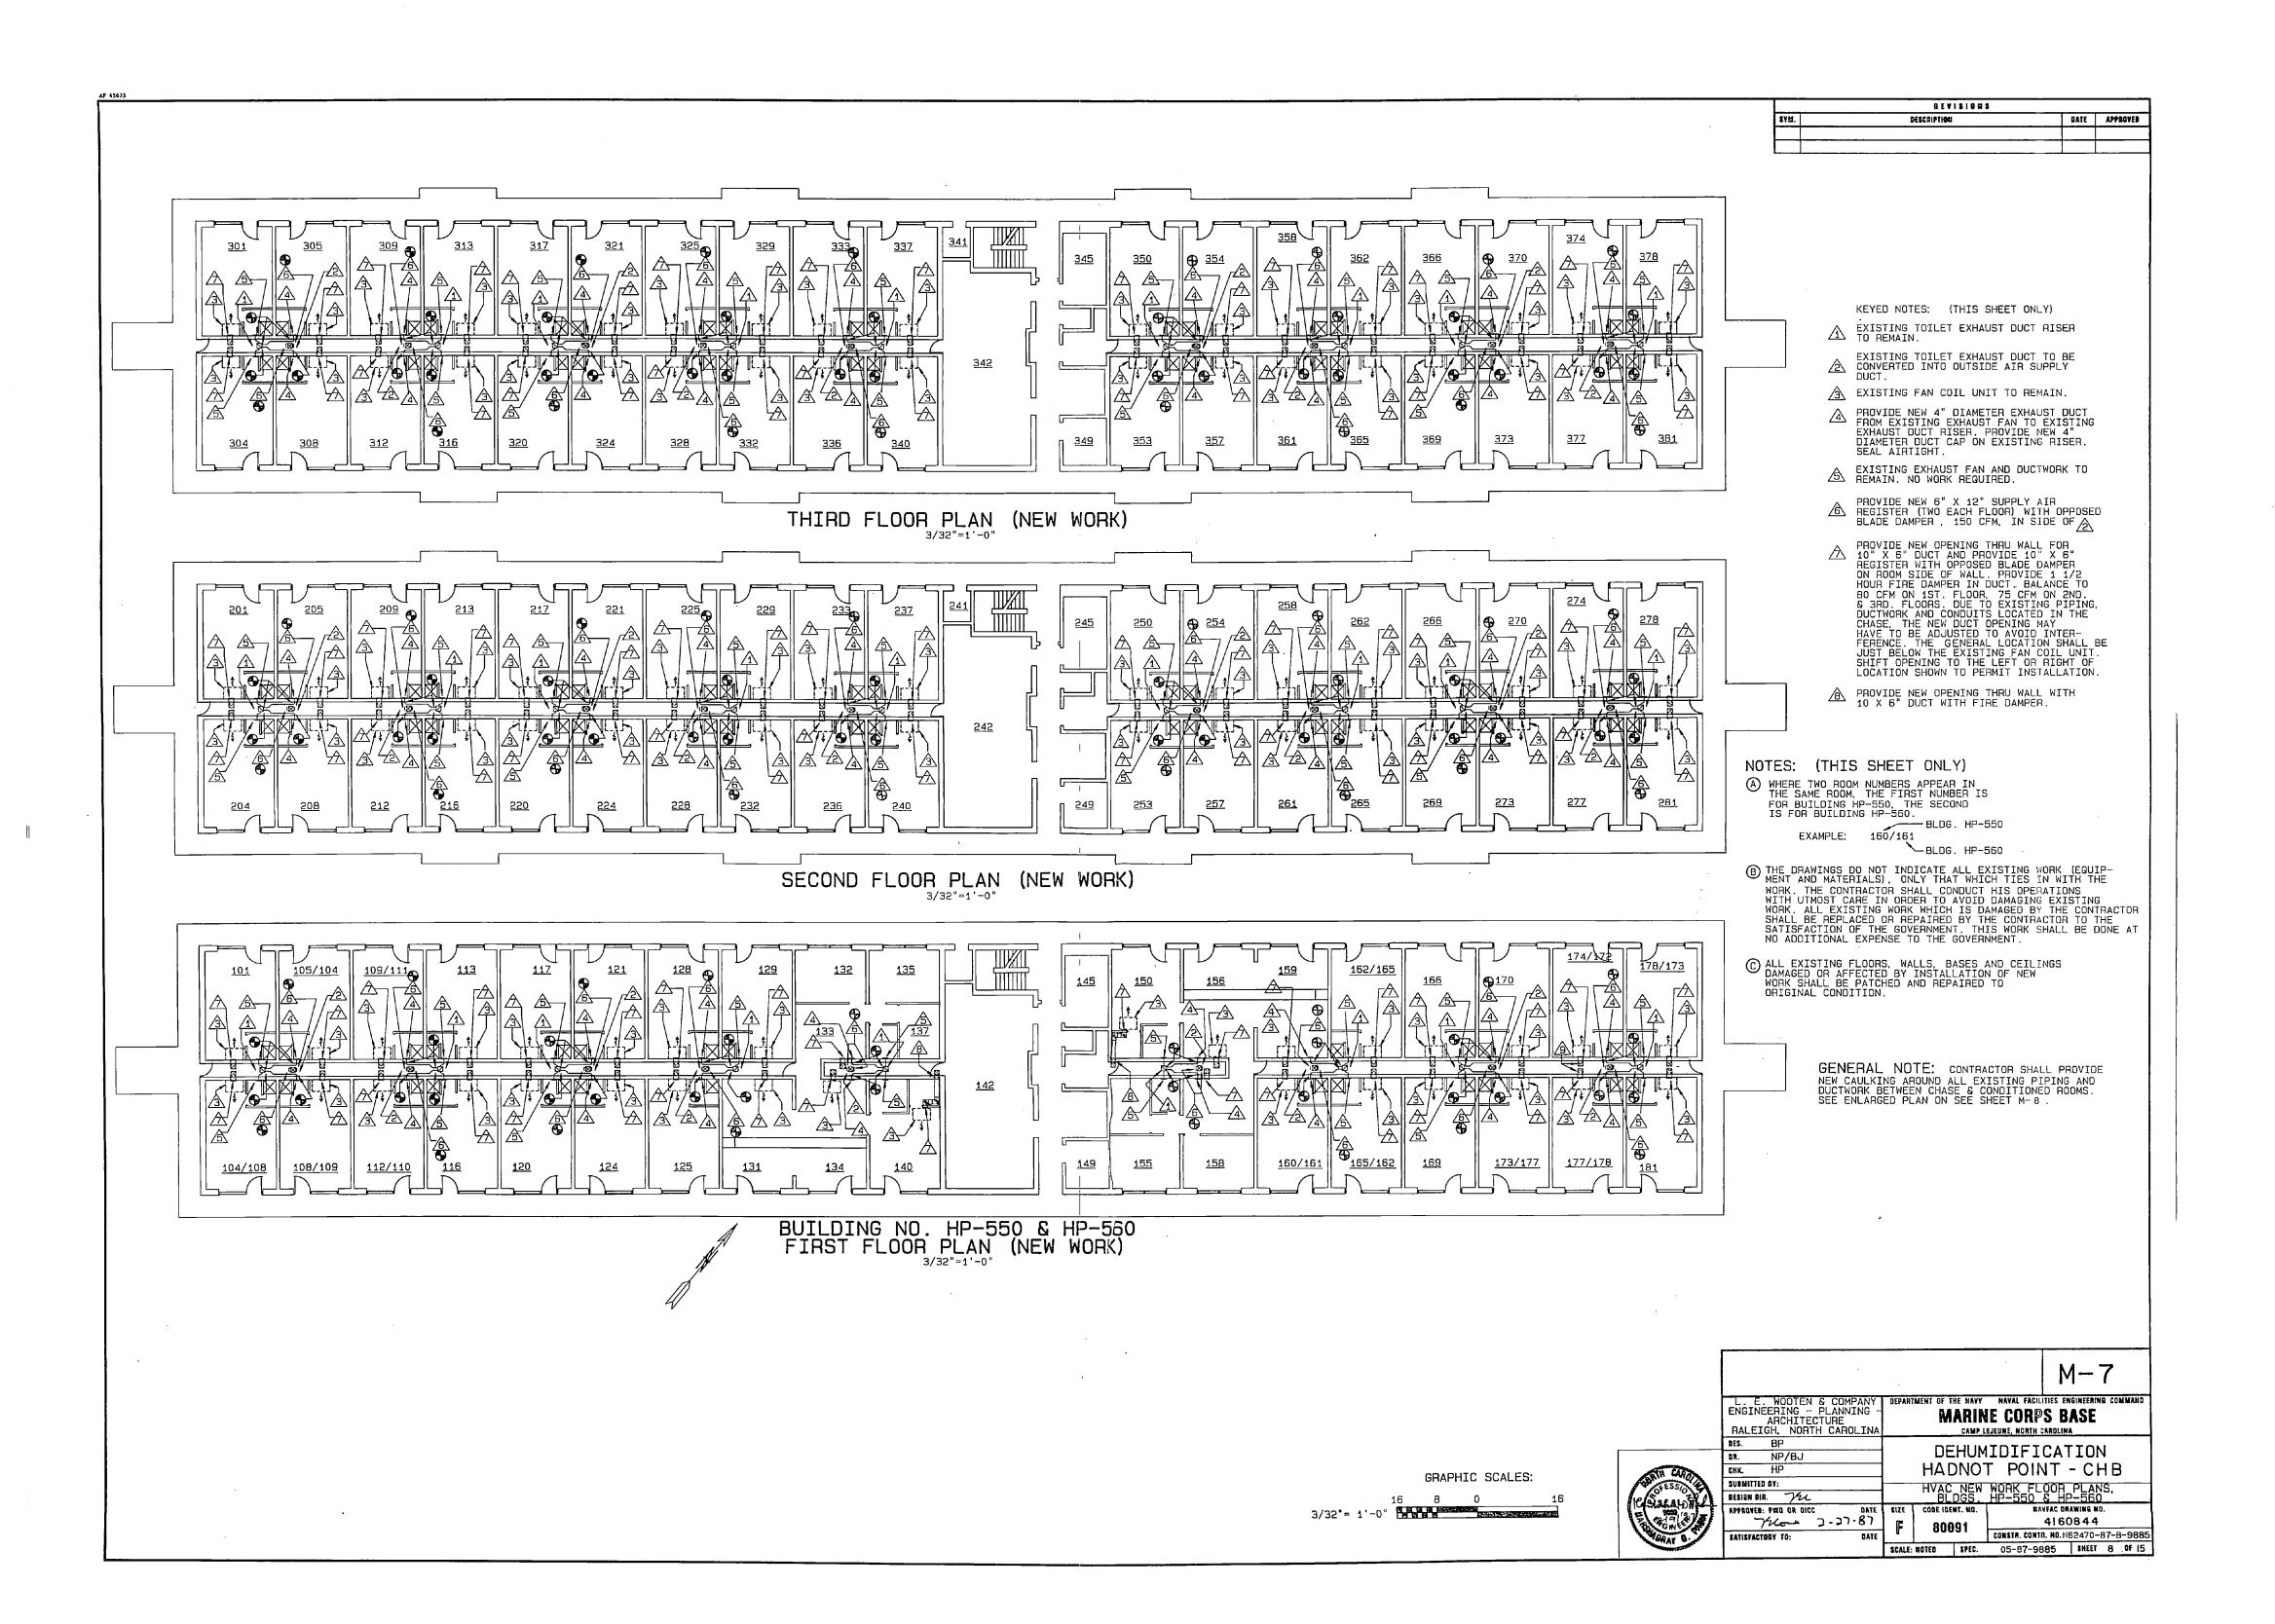
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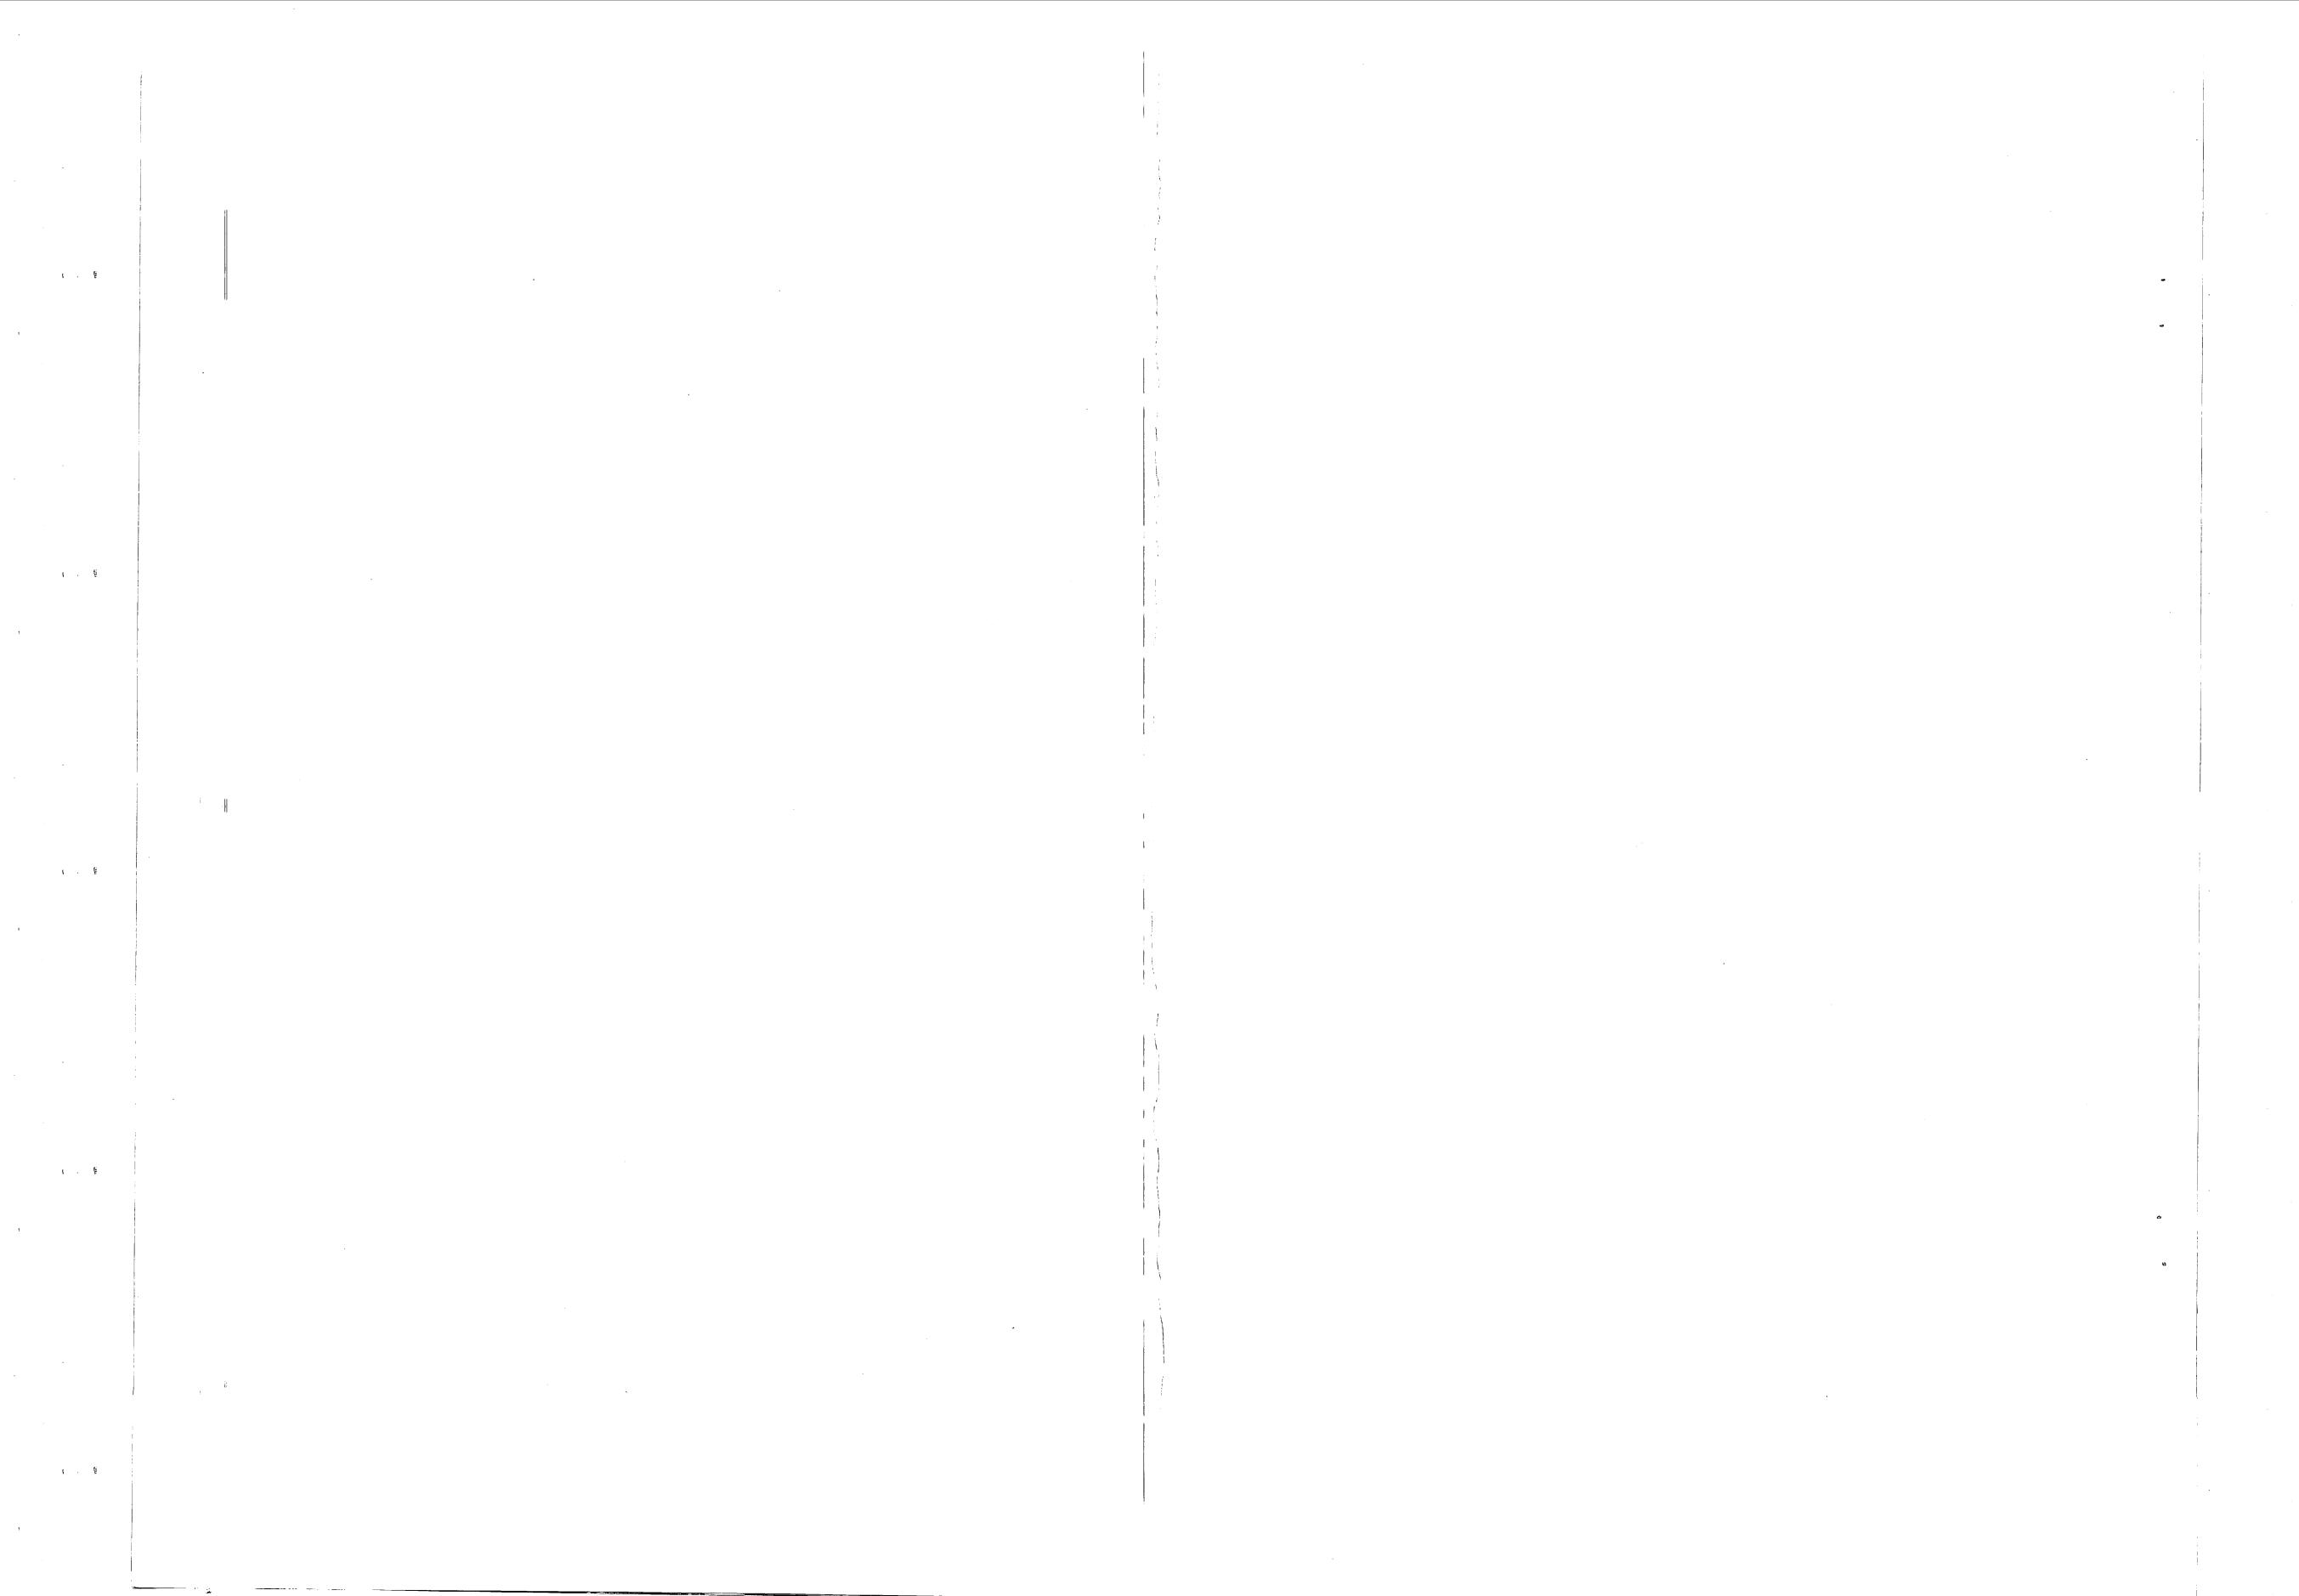
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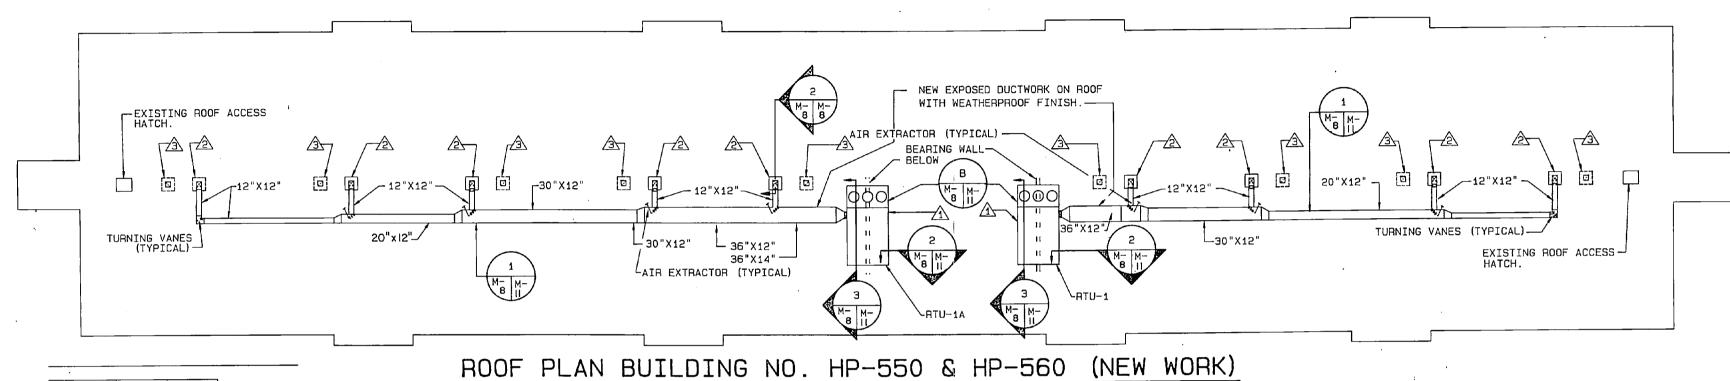


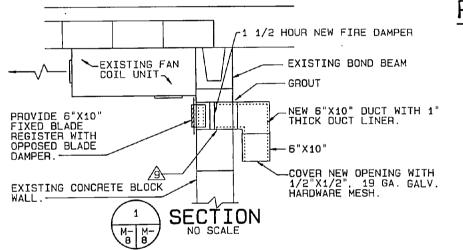
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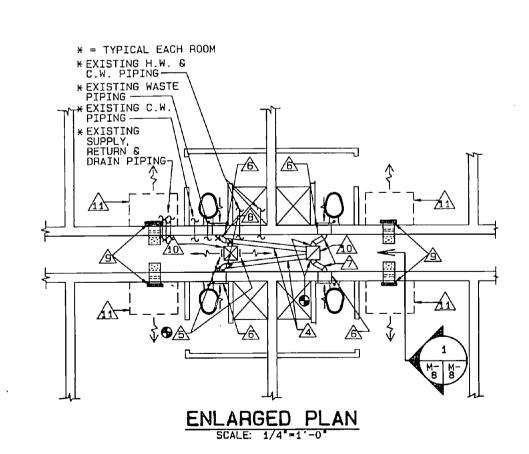
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REMARKS	

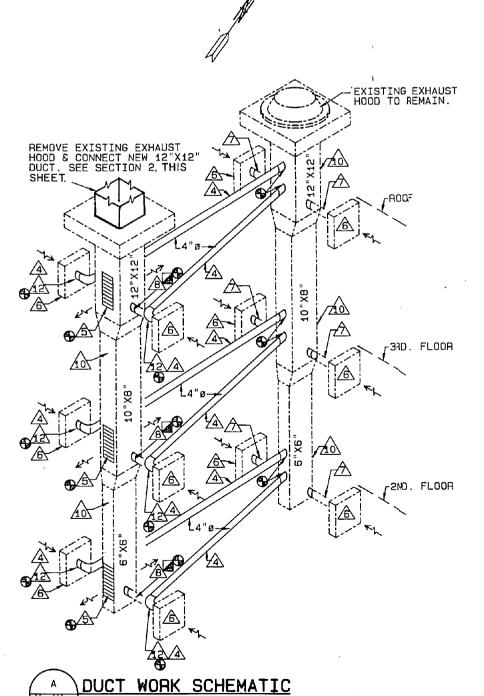
						SI	NGL	_E	F	PAC	KA	GE		CO	OL:	ING	U	NIT	SCH	IEDUL	_E				
A LI II				C.F.M.			LY FAN		OUTE FA	DOOR NS	cc	MPRESS	OR	ELE: SERV	CT. /ICE	COND.	EVAP.	LVG. AIR 1	TEMP. DEG. F	В.Т.И.	H. COOLING	CAPACITY	UNIT FIL	TERS	REMARKS
A.H.U. NO.	LOCATION	SERVING	TOTAL	RETURN	O.A.	EXT. S.P. IN H20	н.Р.	R.P.M.	NO.	F.L.A.	NO.	REFA.	K.W.	VOLTS	PHASE	DEG. F.	E.W.B.T DEG. F.	DRY BULB	WET BULB	SENSIBLE	LATENT	TOTAL	TYPE	EFF.	ACMANINO
ATU-1	ROOF	BEO'S	3600		3600	.5	1 1/2	680	2	5.2	1	H-55	25.9	208	3	90	79	55	54.5	134, 000	176, 000	310,000	THROW AWAY	25%	
RTU-1A	ROOF	BEQ'S	4520		4520	.6	2	700	3	5.2	1	R-22	33.4	208	3	90	79	55	54.5	170, 800	223, 400	394, 200	THROW	25%	

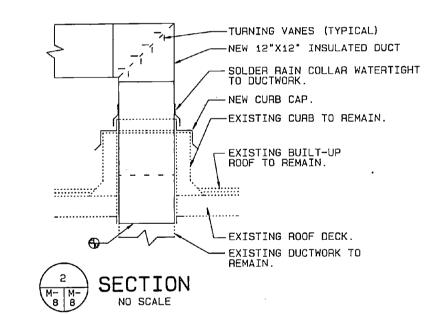




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NOTES: (THIS SHEET ONLY) A. THE DRAWINGS DO NOT INDICATE ALL EXISTING WORK (EQUIP-MENT AND MATERIALS), ONLY THAT WHICH TIES IN WITH THE WORK. THE CONTRACTOR SHALL CONDUCT HIS OPERATIONS WITH UTMOST CARE IN ORDER TO AVOID DAMAGING EXISTING WORK. ALL EXISTING WORK WHICH IS DAMAGED BY THE CONTRACTOR SHALL BE REPLACED OR REPAIRED BY THE CONTRACTOR TO THE SATISFACTION OF THE GOVERNMENT. THIS WORK SHALL BE DONE AT NO ADDITIONAL EXPENSE TO THE GOVERNMENT.

- ALL EXISTING FLOORS, WALLS, BASES AND CEILINGS DAMAGED OR AFFECTED BY INSTALLATION OF NEW WORK SHALL BE PATCHED AND REPAIRED TO ORIGINAL CONDITION.
- PROVIDE TEMPORARY PLYWOOD WALKWAYS FOR PROTECTION OF EXISTING ROOF. WHERE THE EXISTING ROOF IS DAMAGED OR PENETRATED BY INSTALLATION OF NEW WORK, THE CONTRACTOR SHALL EMPLOY A ROOF INSTALLER, TRAINED AND CERTIFIED BY THE MANUFACTURER OF THE ROOFING SYSTEM, TO MAKE NECESSARY REPAIRS TO ENSURE THAT ROOF WARRANTY IS NOT VOIDED.

KEYED NOTES: (THIS SHEET ONLY) PROVIDE NEW ROOF TOP UNIT WITH EQUIPMENT SUPPORT CURB AND BUILT IN CANT STRIP. CURB SHALL BE BUILT FOR PITCHED ROOF TO KEEP TOP OF CURB LEVEL.CENTER UNIT OVER BEARING WALL BELOW

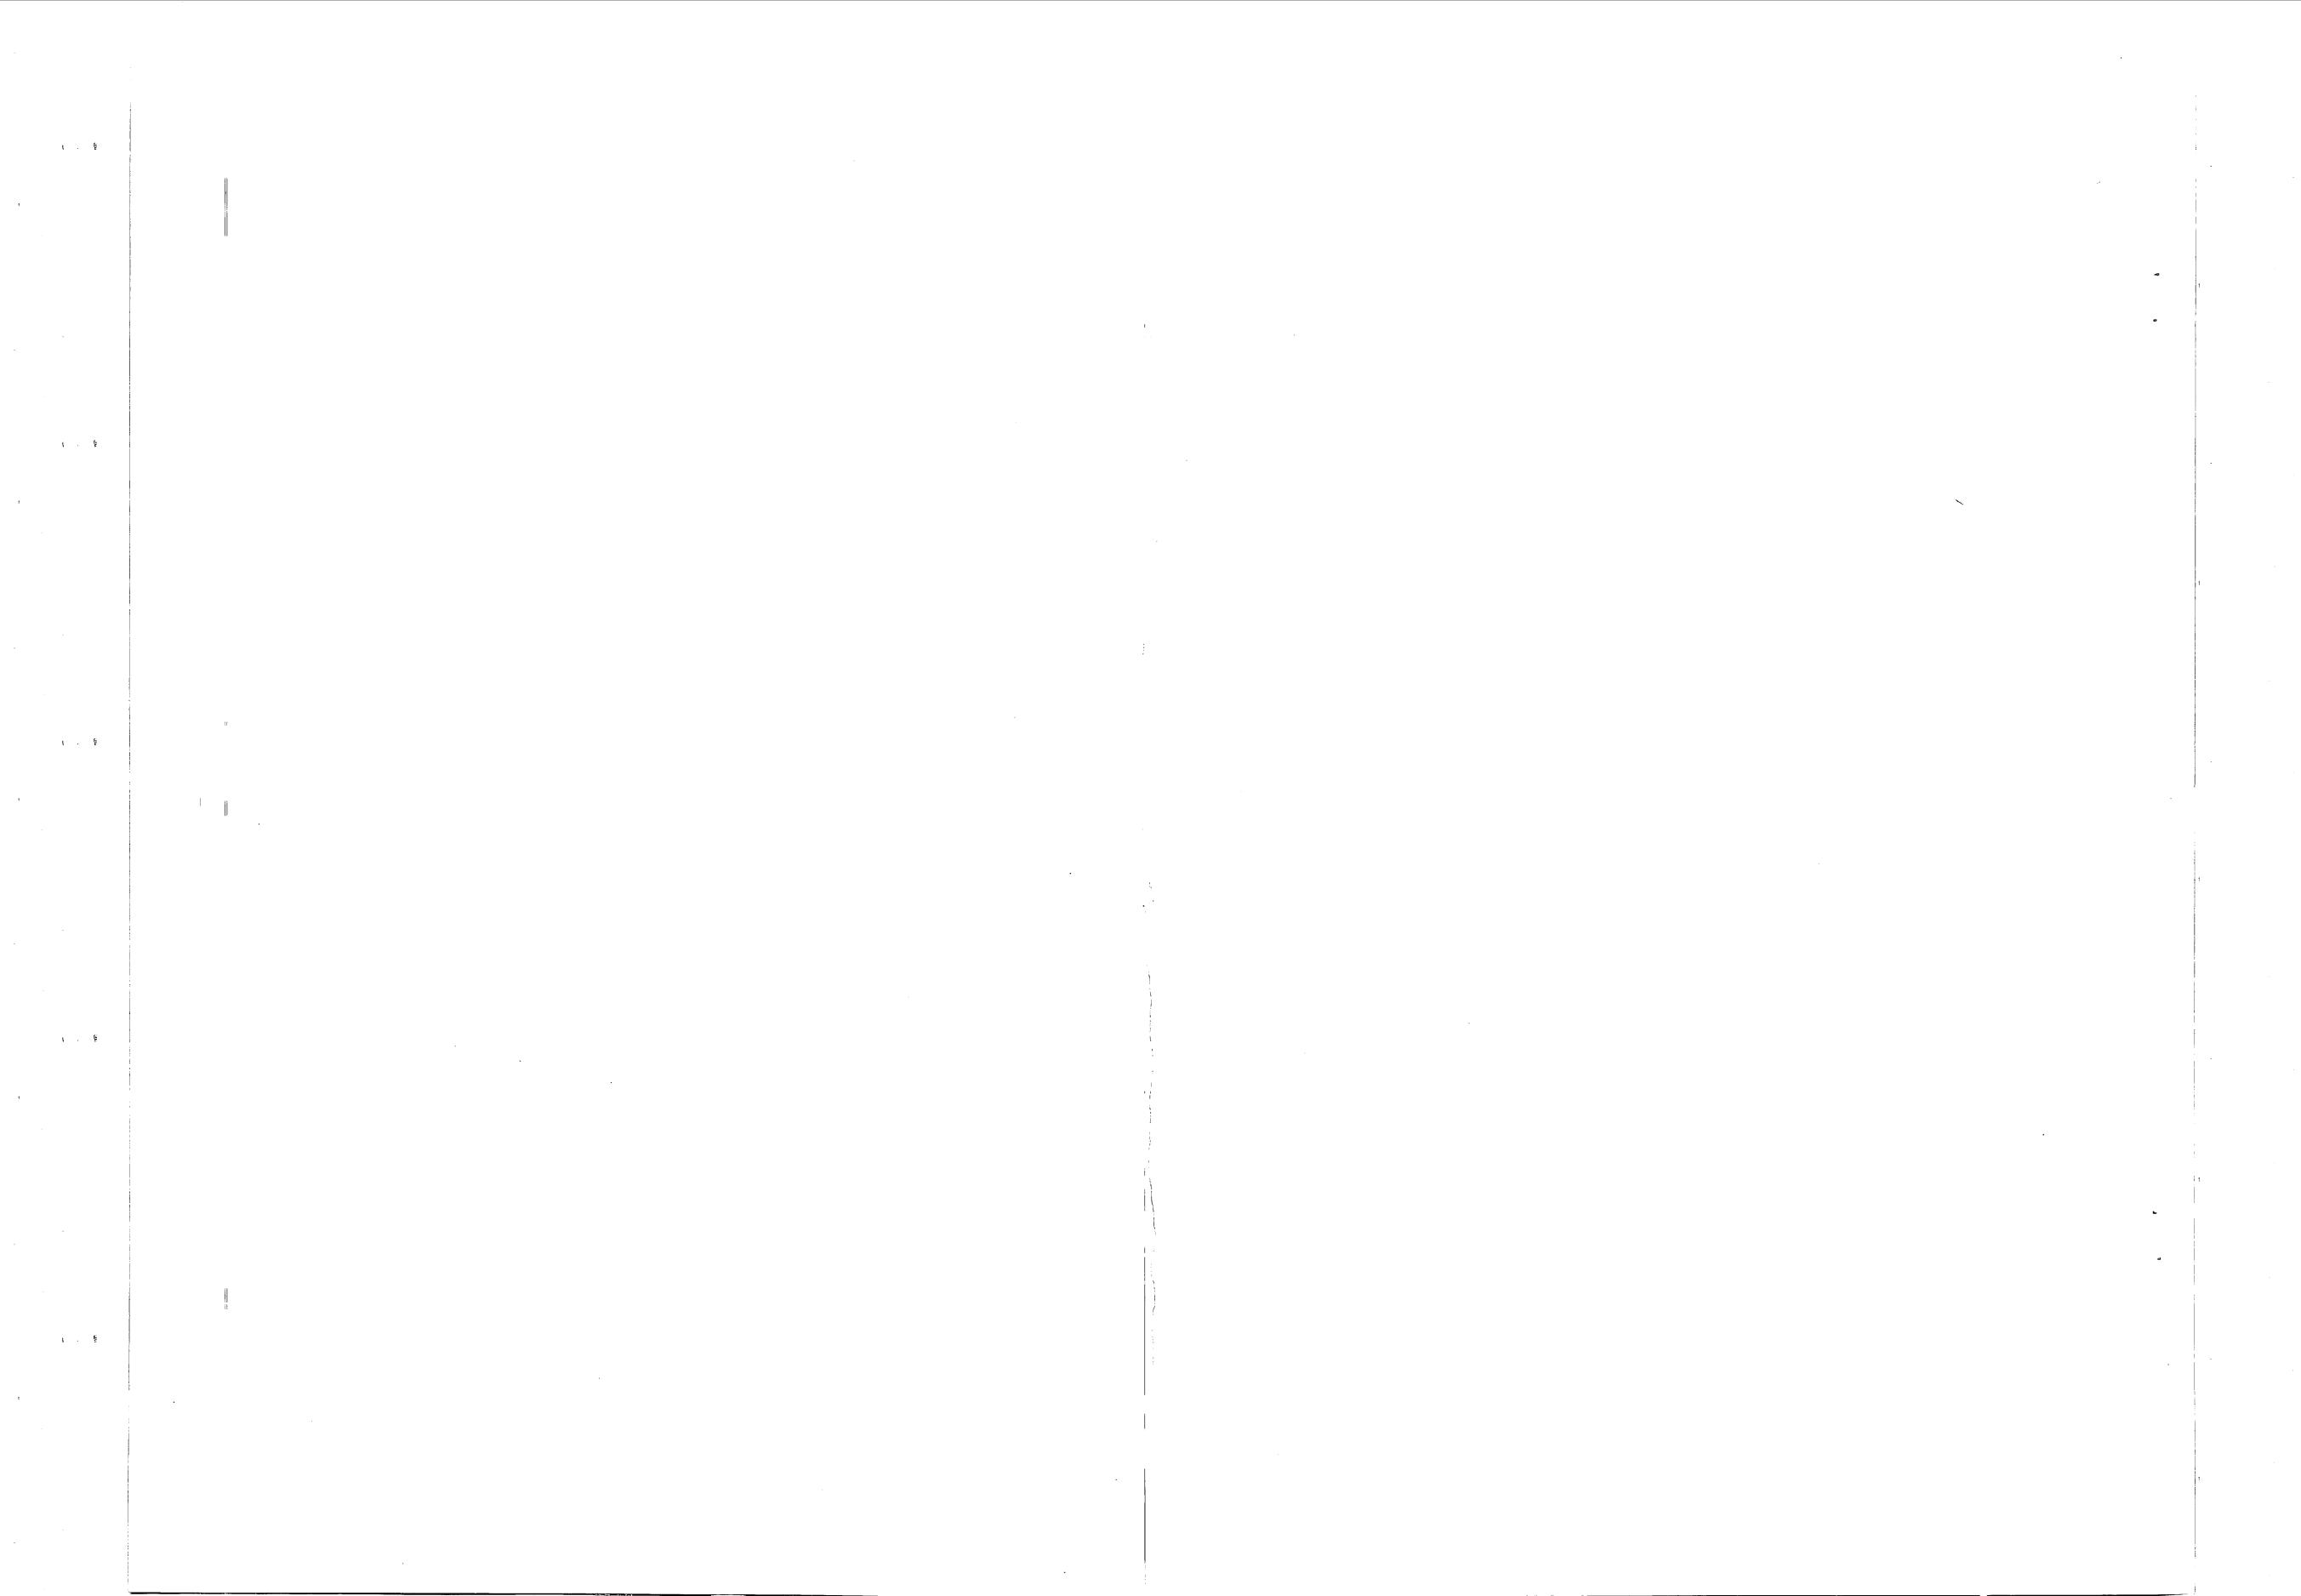
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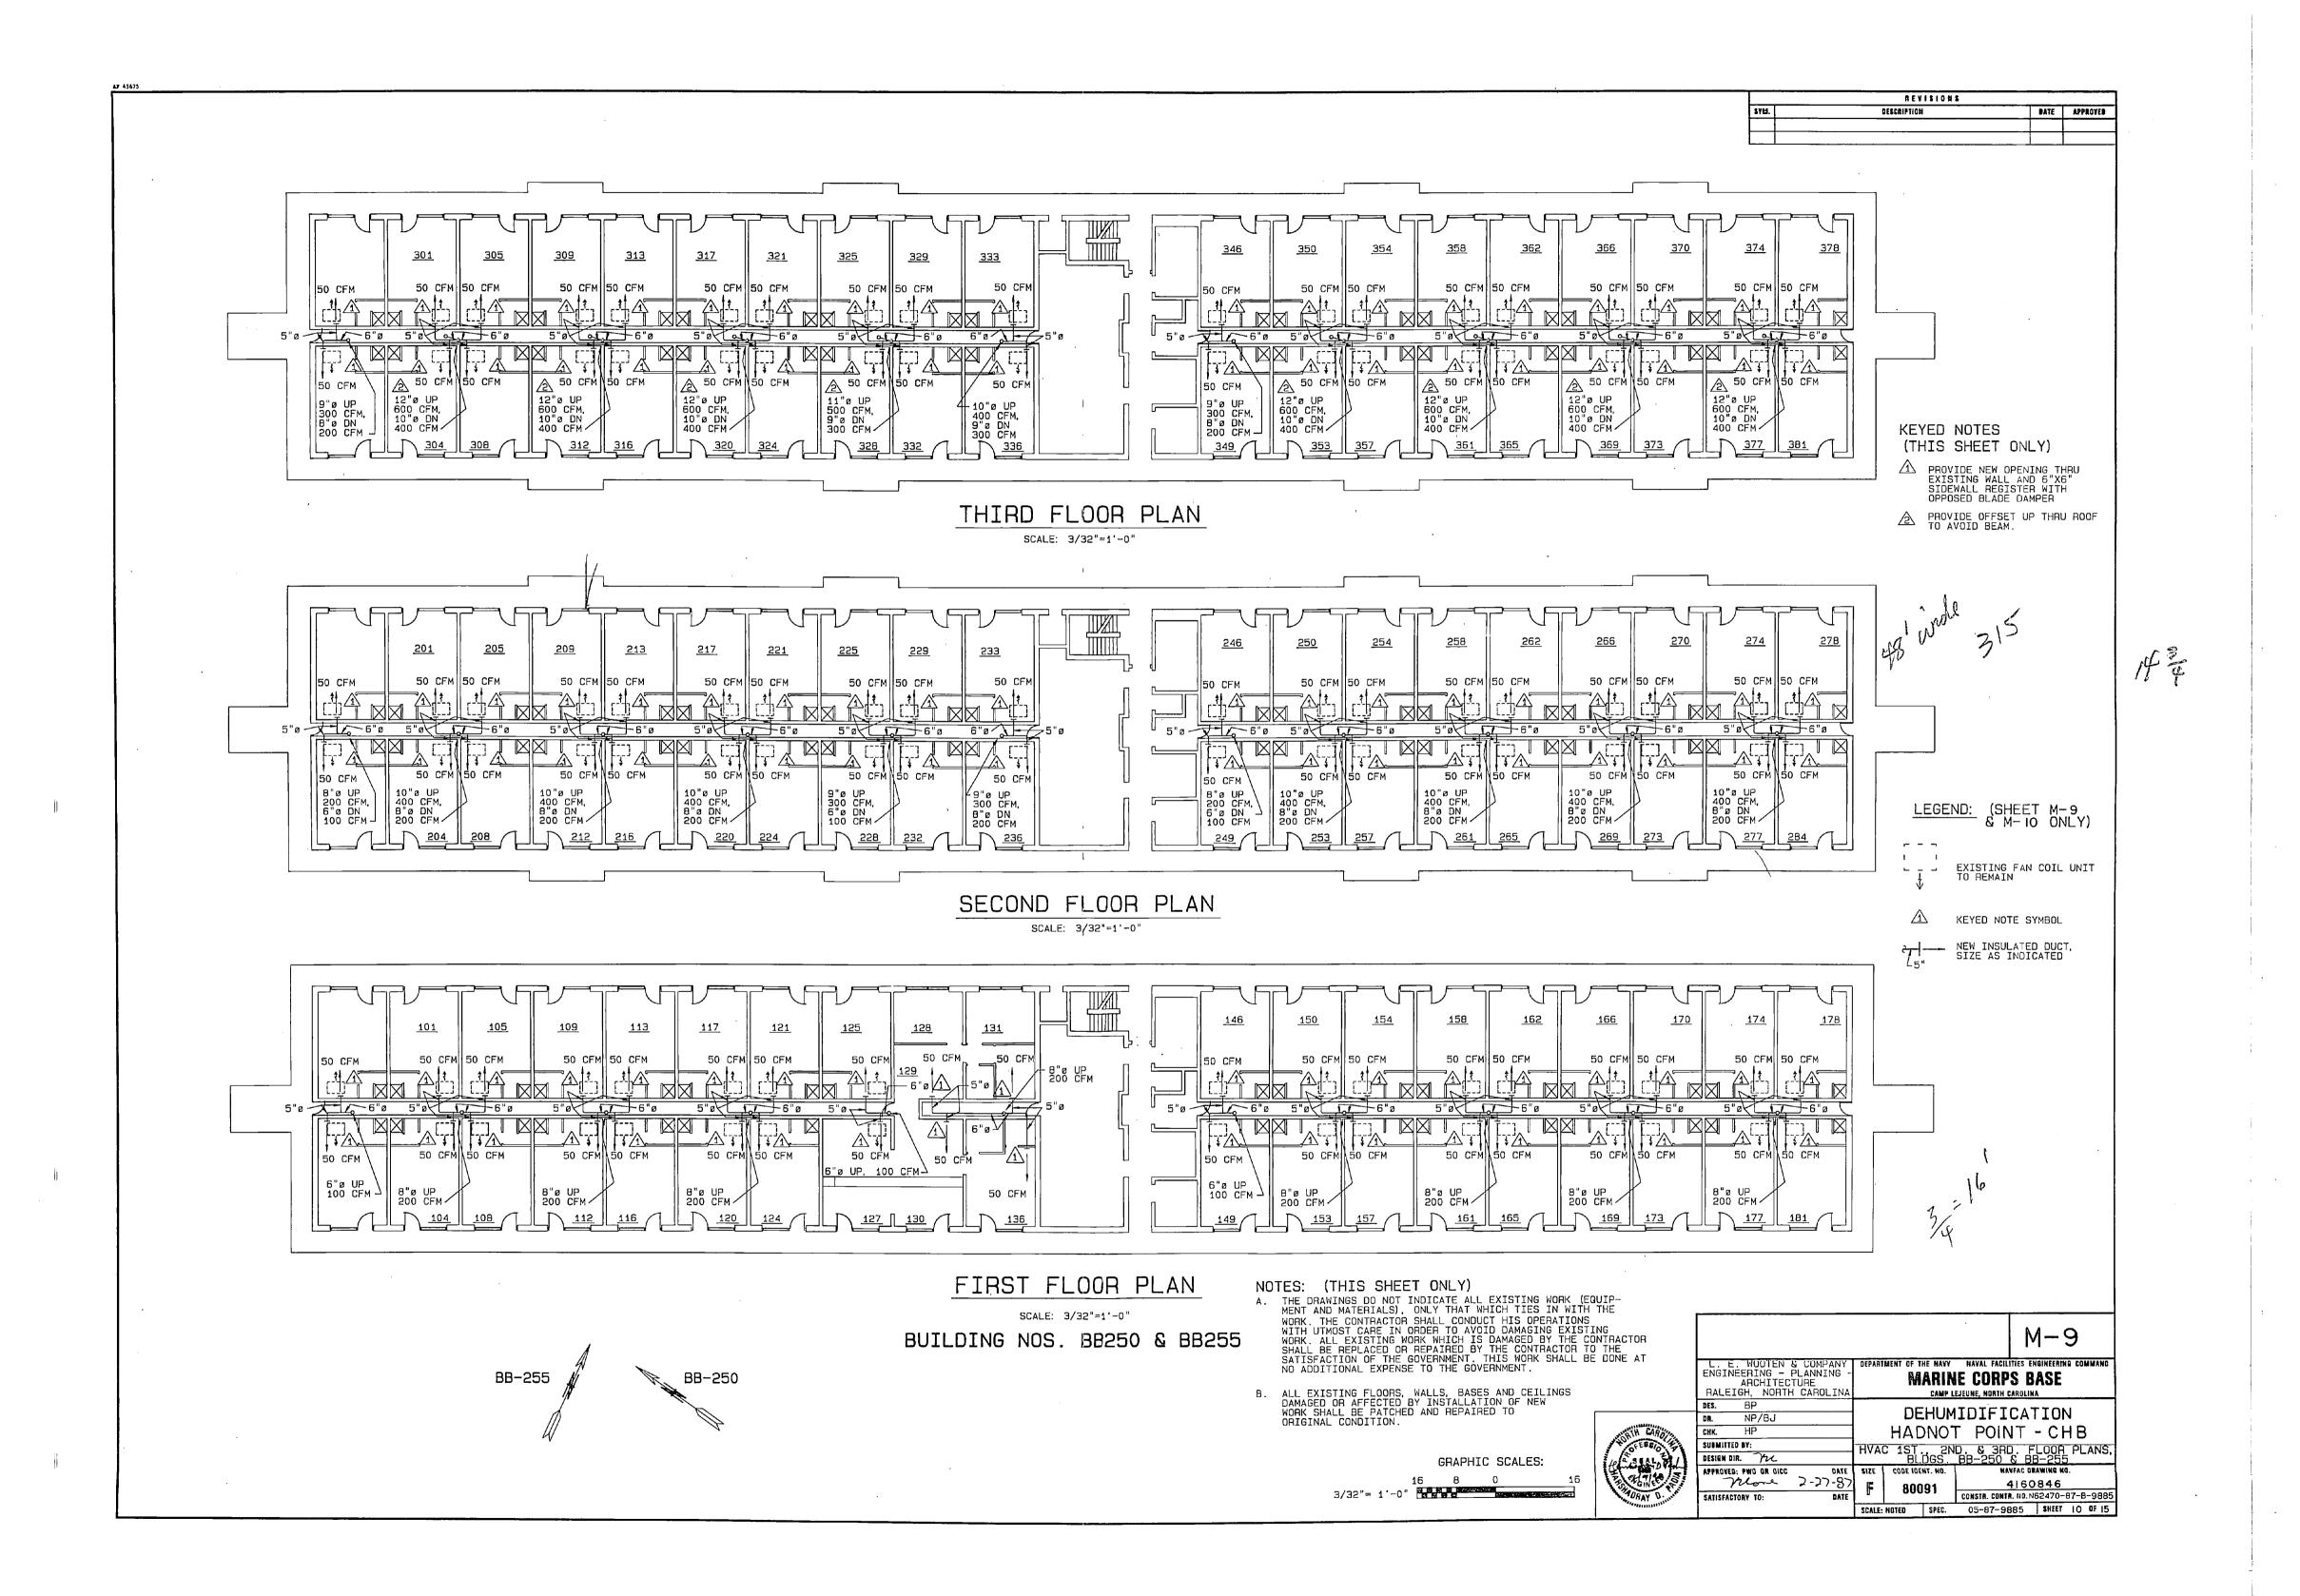
DATE APPROVES

- REMOVE EXISTING EXHAUST HOOD AND PROVIDE NEW 12"X12" DUCT CONNECTION TO EXISTING EXHAUST DUCT. PROVIDE NEW CURB CAP AND RAIN COLLAR.
- A EXISTING TOILET EXHAUST HOOD TO REMAIN.
- PROVIDE NEW 4" DIAMETER FLEXIBLE DUCT.
- PROVIDE NEW 6" X 12" SUPPLY AIR REGISTER WITH OPPOSED BLADE DAMPER, TYPICAL BOTH SIDES, 150 CFM EACH.
- EXISTING TOILET EXHAUST FAN TO REMAIN, 65 CFM.
- EXISTING 4" DIAMETER EXHAUST DUCT TO REMAIN.
- REMOVE EXISTING 4" DIAMETER DUCT. PROVIDE NEW 4" DIAMETER CAP OVER EXISTING OPENING, SEAL AIRTIGHT. TYPICAL BOTH SIDES.
- PROVIDE NEW OPENING THRU WALL FOR 10" X 6" DUCT AND PROVIDE 10" X 6" REGISTER WITH OPPOSED BLADE DAMPER ON ROOM SIDE OF WALL. PROVIDE 1 1/2 HOUR FIRE DAMPER IN DUCT, SEE SECTION 1, THIS SHEET.
- EXISTING DUCTWORK TO REMAIN.
- EXISTING FAN COIL UNIT TO REMAIN.
- REMOVE EXISTING 4" DIAMETER EXHAUST DUCT.

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L. E. WOOTEN & COMPANY ENGINEERING - PLANNING -	DEPART	MENT OF T		MAYAL FACILITIES EN				
ARCHITECTURE RALEIGH. NORTH CAROLINA				E CORPS BA				
DES. BP								
DR. NP/BJ				IDIFICAT				
CHK. HP	HADNOT POINT - CHB							
SUBMITTED BY:		HVA	C AO	OF PLANS. BI	_DGS.			
BESIGN DIR. TEL			HP-	OF PLANS, BI 550 & HP-56	0			
APPROVEB: PWO OR DICC DATE	812E	CORE IDE	MT. HD.	NAVFAC DR				
Those 2-27-97	E	80091		4160845				
SATISFACTORY TO: DATE	u	000	•	CONSTR. CONTR. NO. N62470-87-8-9885				
	SCALE:	CATER	SPEC.	05-8 7-9885	SHEET 9 6F 15			

GRAPHIC SCALES: 3/32"= 1'-0" 1/4"= 1'-0" 4'3'2'1'0' 2' 4' 6' 8' 10' 12'

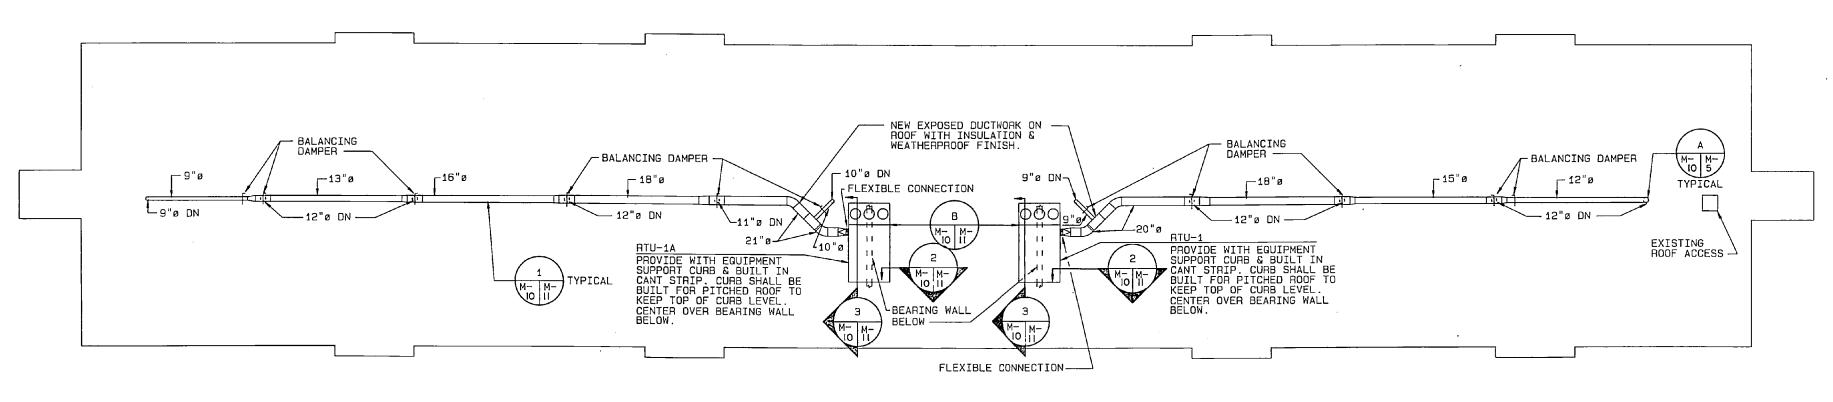




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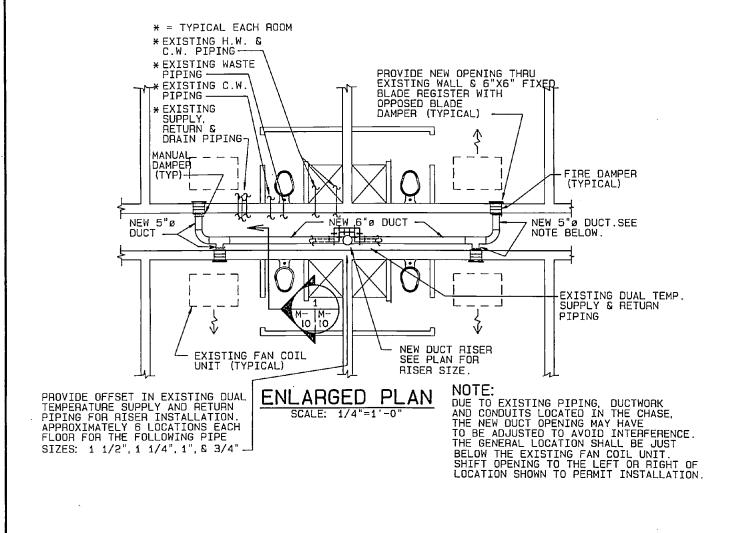
REVISIONS DESCRIPTION

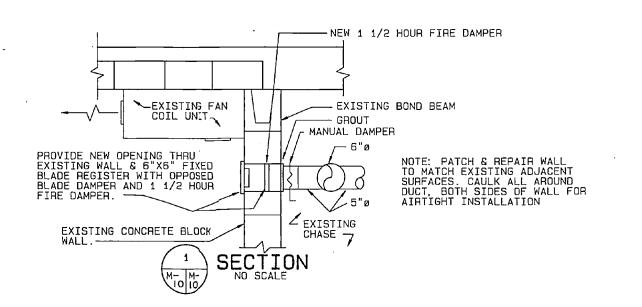


ROOF PLAN - BUILDINGS NO. BB-250 & BB-255

SCALE : 3/32"=1'-0"

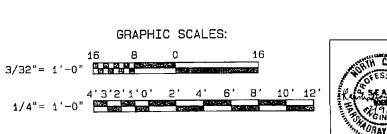
						SI			F	PAC	CKA	GE	,,,	CO	OL:	ING	U	NIT	SCH	IEDUL	_E				
A.H.U	LOCATION	SERVING		C.F.M.		SUPP EXT. S.P.	PLY FAN		OUTDOOR COMPRESSOR		SOR	ELECT. COND. EVAP.				ND. EVAP. LVG. AIR TEMP. DEG. F B.T.U.H. COOLING CAPACITY				UNIT FILTERS		DEW SKG			
A.H.U NO.	LOCATION	SEHVING	TOTAL	RETURN	O.A.	IN H50	н.р.	R.P.M.	NO.	F.L.A.	NO.	REFR.	K.W.	VOLTS	PHASE	PHASE DEG. F. E	E.W.B.T DEG. F. DAY BUL	DRY BULB	WET BULB	SENSIBLE	LATENT	TOTAL	TYPE	EFF.	REMARKS
RTU-1	ROOF	BEG'S	2700		2700	.6	1	650	2	5.2	1	R-22	17.9	208	3	90	79	55	54.5	103, 000	131, 000	234, 000	THROW AWAY	25%	
RTU-1	ROOF	BEQ'S	3000		3000	.6	1	660	2	5.2	1	H-55	22.8	208	3	90	79	55	54.5	113, 400	148, 200	261, 600	THROW YAWA	25%	

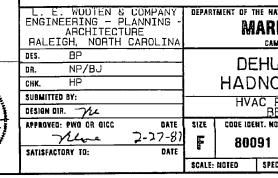




- NOTES: (THIS SHEET ONLY)

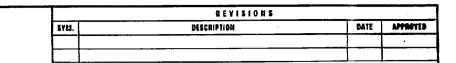
 A. THE DRAWINGS DO NOT INDICATE ALL EXISTING WORK (EQUIPMENT AND MATERIALS), ONLY THAT WHICH TIES IN WITH THE WORK. THE CONTRACTOR SHALL CONDUCT HIS OPERATIONS WITH UTMOST CARE IN ORDER TO AVOID DAMAGING EXISTING WORK. ALL EXISTING WORK WHICH IS DAMAGED BY THE CONTRACTOR SHALL BE REPLACED OR REPAIRED BY THE CONTRACTOR TO THE SATISFACTION OF THE GOVERNMENT. THIS WORK SHALL BE DONE AT NO ADDITIONAL EXPENSE TO THE GOVERNMENT.
- B. ALL EXISTING FLOORS, WALLS, BASES AND CEILINGS DAMAGED OR AFFECTED BY INSTALLATION OF NEW WORK SHALL BE PATCHED AND REPAIRED TO ORIGINAL CONDITION.
- C. PROVIDE TEMPORARY PLYWOOD WALKWAYS FOR PROTECTION OF EXISTING ROOF. WHERE THE EXISTING ROOF IS DAMAGE OR PENETRATED BY INSTALLATION OF NEW WORK, THE CONTRACTOR SHALL EMPLOY A ROOF INSTALLER, TRAINED AND CERTIFIED BY THE MANUFACTURER OF THE ROOFING SYSTEM, TO MAKE NECESSARY REPAIRS TO ENSURE THAT ROOF WARRANTY IS NOT VOIDED.

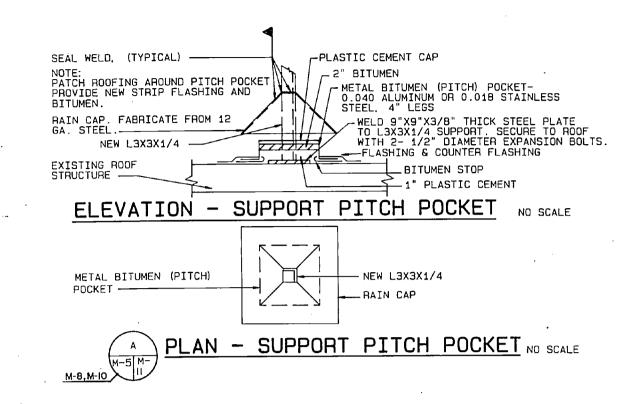


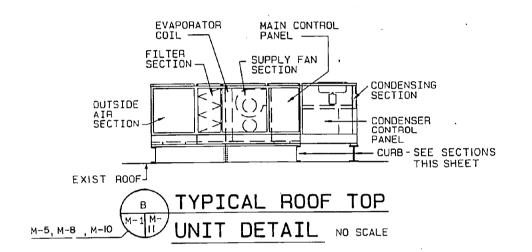


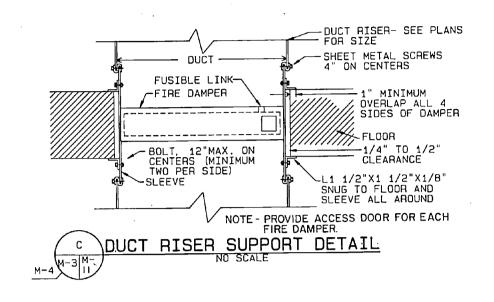
MARINE CORPS BASE CAMP LEJEUNE, NORTH CAROLINA DEHUMIDIFICATION HADNOT POINT - CHB HVAC ROOF PLANS, BLDGS. BB-250 & BB-255 HAYFAC DRAWING NO. 4160847 CONSTR. CONTR. NO. N62470-87-8-9885 SCALE: HOTED SPEC. 05-87-9885 SHEET 11 OF 15

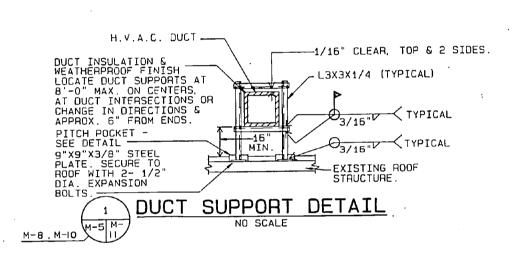
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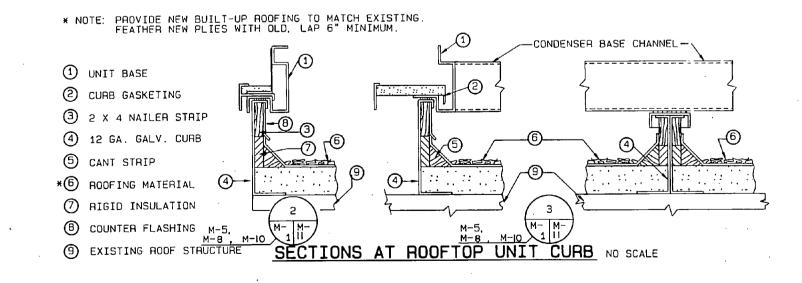












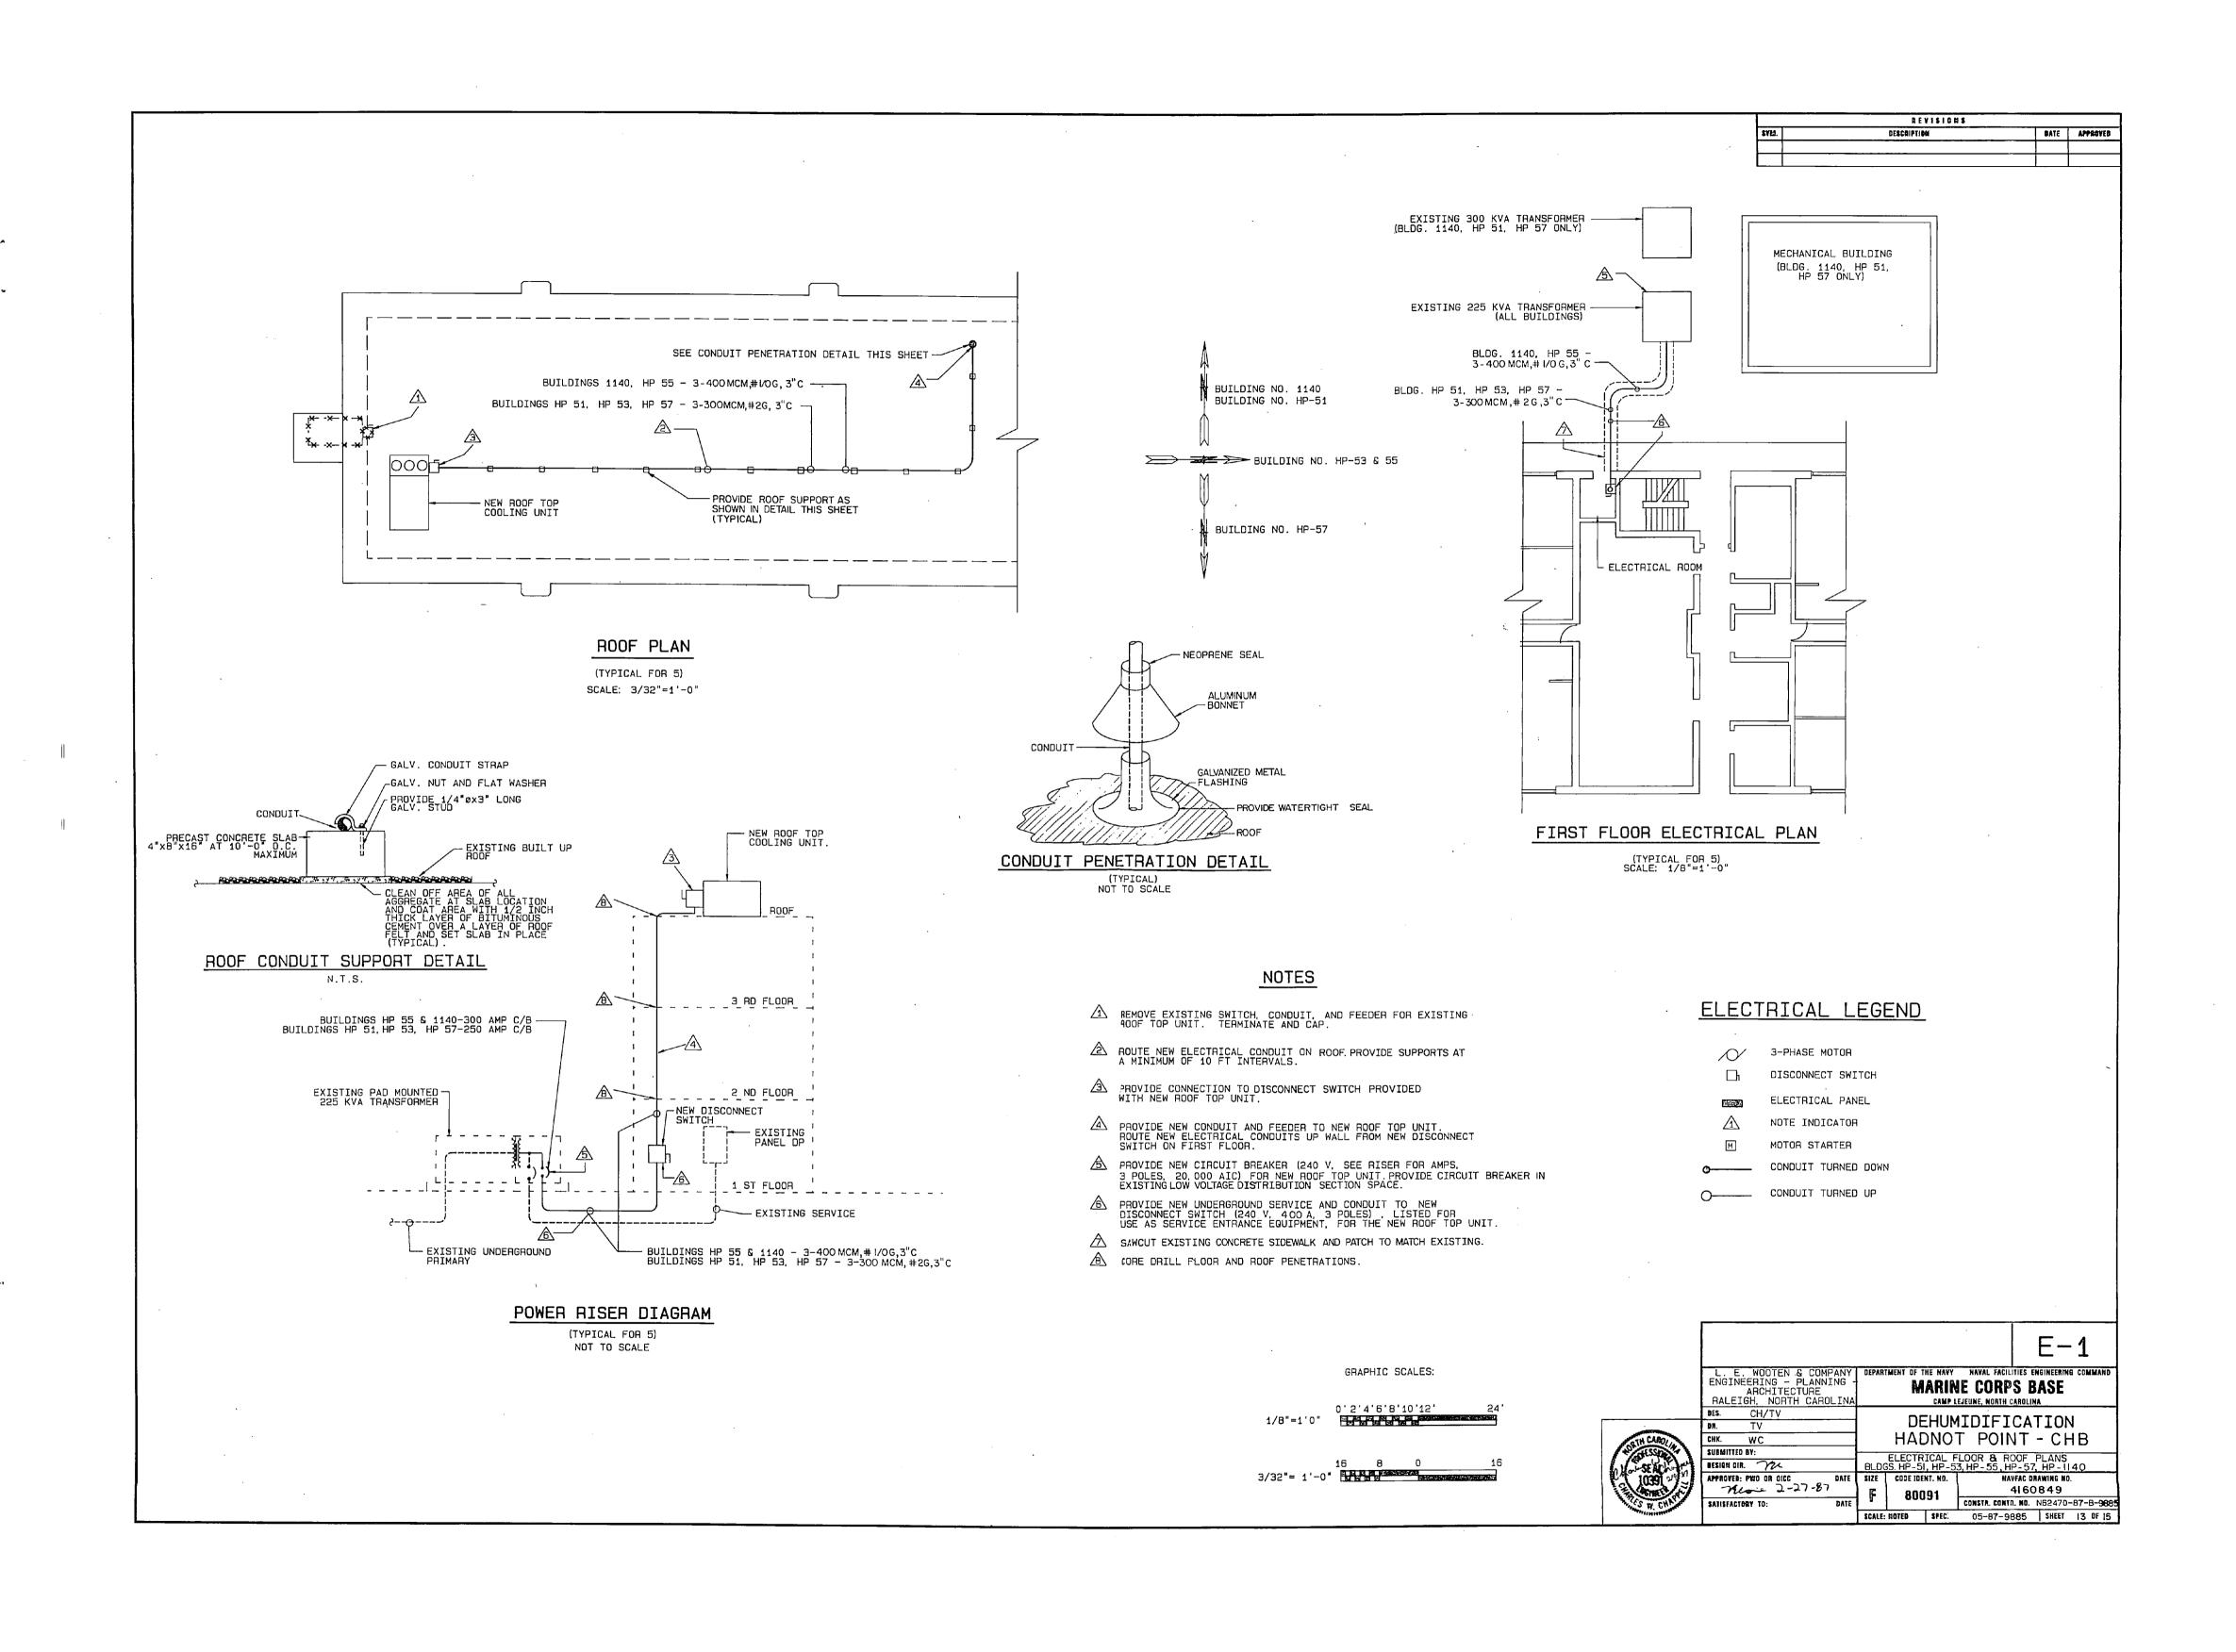
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L. E. WOUTEN & COMPANY ENGINEERING - PLANNING ARCHITECTURE RALEIGH, NORTH CAROLINA	DEPARTMENT OF THE NAVY HAVAL FACILITIES ENGINEERING COMMAND MARINE CORPS BASE CAMP LEJEUNE, NORTH CAROLINA							
			CAMPL	EJEUNE, MURIN CANULINA	·			
DES. BP	DEHUMIDIFICATION							
DM. NP/BJ								
CHK. HP		HAL	ONG	OT POINT - CHB				
SUBMITTED BY:	HVAC DETAILS							
BESIBN BIR. YK								
APPROVED: PWD UR GICC DATE	SIZE	COBE IDE	NT. NO.	MAYFAC BR	AWING NO.			
-yelone 2-27.81		800	04	4160	848			
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GRAPHIC SCALES:

-1'-0"

GRAPHIC SCALES:



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BUILDINGS 897 & 898

NOTES

EXISTING MDP (FEDERAL PACIFIC, 120/280V, 3 \$\phi\$
4W, 1800A MAIN C/B)

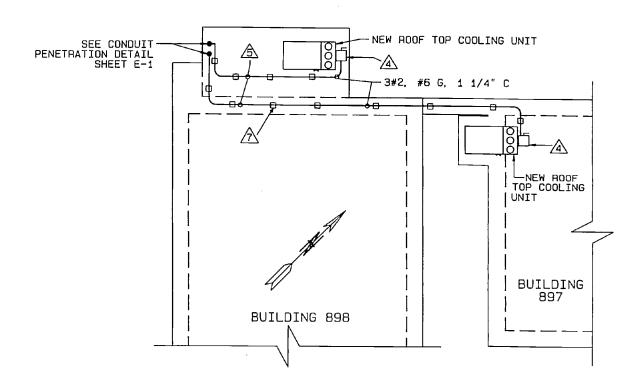
MECHANICAL ROOM

- PROVIDE NEW FEEDER, CONDUIT AND CIRCUIT BREAKER (240 V, 150 A, 3 POLES, 20,000 AIC) IN EXISTING PANEL MOP FOR NEW ROOF TOP UNIT ON BUILDING 898.
- PROVIDE NEW FEEDER, CONDUIT AND CIRCUIT BREAKER (240 V, 150 A, 3 POLES, 20,000 AIC) IN EXISTING PANEL MOP FOR NEW HOOF TOP UNIT ON BUILDING B97.
- PROVIDE NEW CONDUITS UP, SEE POWER RISER DIAGRAM THIS SHEET.

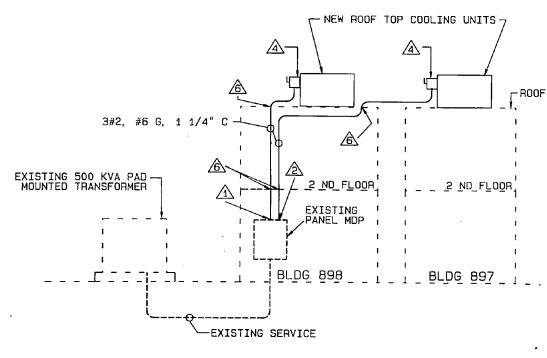
 PROVIDE CONNECTIONS TO DISCONNECT SWITCHES (240V,200A,3 POLE, NEMA 3R) PROVIDED WITH THE NEW AIR COOLED CHILLERS.
- PROVIDE NEW CONDUIT SUPPORTS AT MAXIMUM 10'-0" INTERVALS.
- CORE DRILL FLOOR AND ROOF PENETRATIONS AND PROVIDE WATERTIGHT SEAL. SEE CONDUIT PENETRATION DETAIL SHEET E-1 FOR ROOF PENETRATION.
- SUPPORT CONDUIT AS SHOWN IN ROOF CONDUIT SUPPORT DETAIL SHEET E-I.

MODIFICATIONS TO MECHANICAL ROOM

SCALE: 1/8"=1'-0"



ROOF PLAN BUILDINGS 897 & 898 SCALE: 1/16"=1'-0"

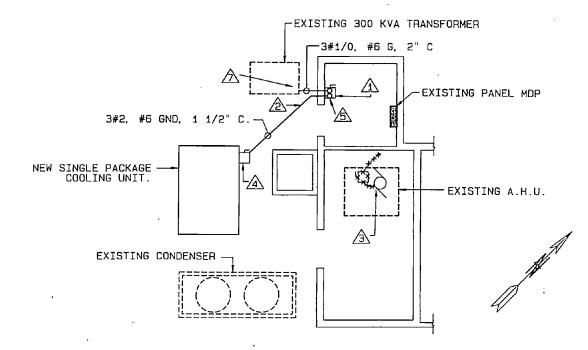


GRAPHIC SCALES:

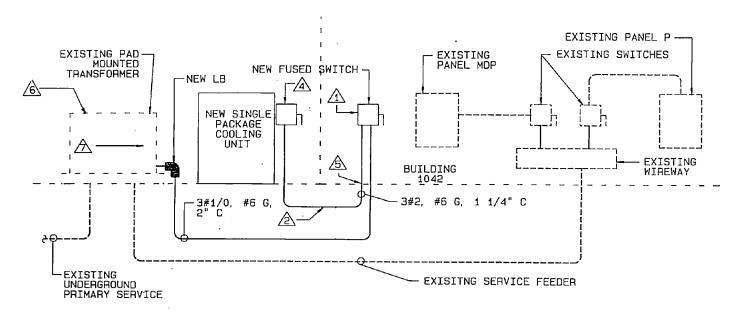
1/8"=1'0" 0'2'4'6'8'10'12'

0'4'8'12'16' 32'

BUILDING 1042



MECHANICAL EQUIPMENT ROOM PLAN
SCALE: 1/8"=1'-0"



POWER RISER DIAGRAM

NOT TO SCALE

NOTES

- PROVIDE NEW FEEDER, CONDUIT AND FUSED DISCONNECT SWITCH (240 V, 150 AMP FUSES, 3 POLES, 20,000 AIC) FOR NEW SINGLE PKG. COOLING UNIT. SWITCH SHALL BE LISTED FOR USE AS SERVICE ENTRANCE EQUIPMENT.
- PROVIDE NEW UNDERGROUND FEEDER AND CONDUIT TO NEW SINGLE PACKAGE COOLING UNIT.
- A REMOVE EXISTING SWITCH, CONDUIT AND FEEDER FOR EXISTING A.H.U. BACK TO PANEL.
- PROVIDE CONNECTION TO DISCONNECT SWITCH (240V,200A,3 POLE, NEMA 3R).
 PROVIDED WITH THE NEW SINGLE PACKAGE COOLING UNIT.
- SAWCUT AND PATCH CONCRETE FLOOR TO MATCH EXISTING.
- TRANSFORMER (300 KVA WESTINGHOUSE A-Y, 12470-208/120).

 PROVIDE NEW LUGS AND CONNECTIONS FOR NEW SERVICE IN THE EXISTING TRANSFORMER ENCLOSURE.

GRAPHIC SCALE:

 L. E. WOOTEN & COMPANY
ENGINEERING - PLANNING ARCHITECTURE
RALEIGH, NORTH CAROLINA

BES. CH/TV

DR. TV

CHK. WC

SUBMITTED BY:

DESIGN BID. 76.

DESIGN BID.

CONSTR. CORTR. NO. N62470-87-8-988

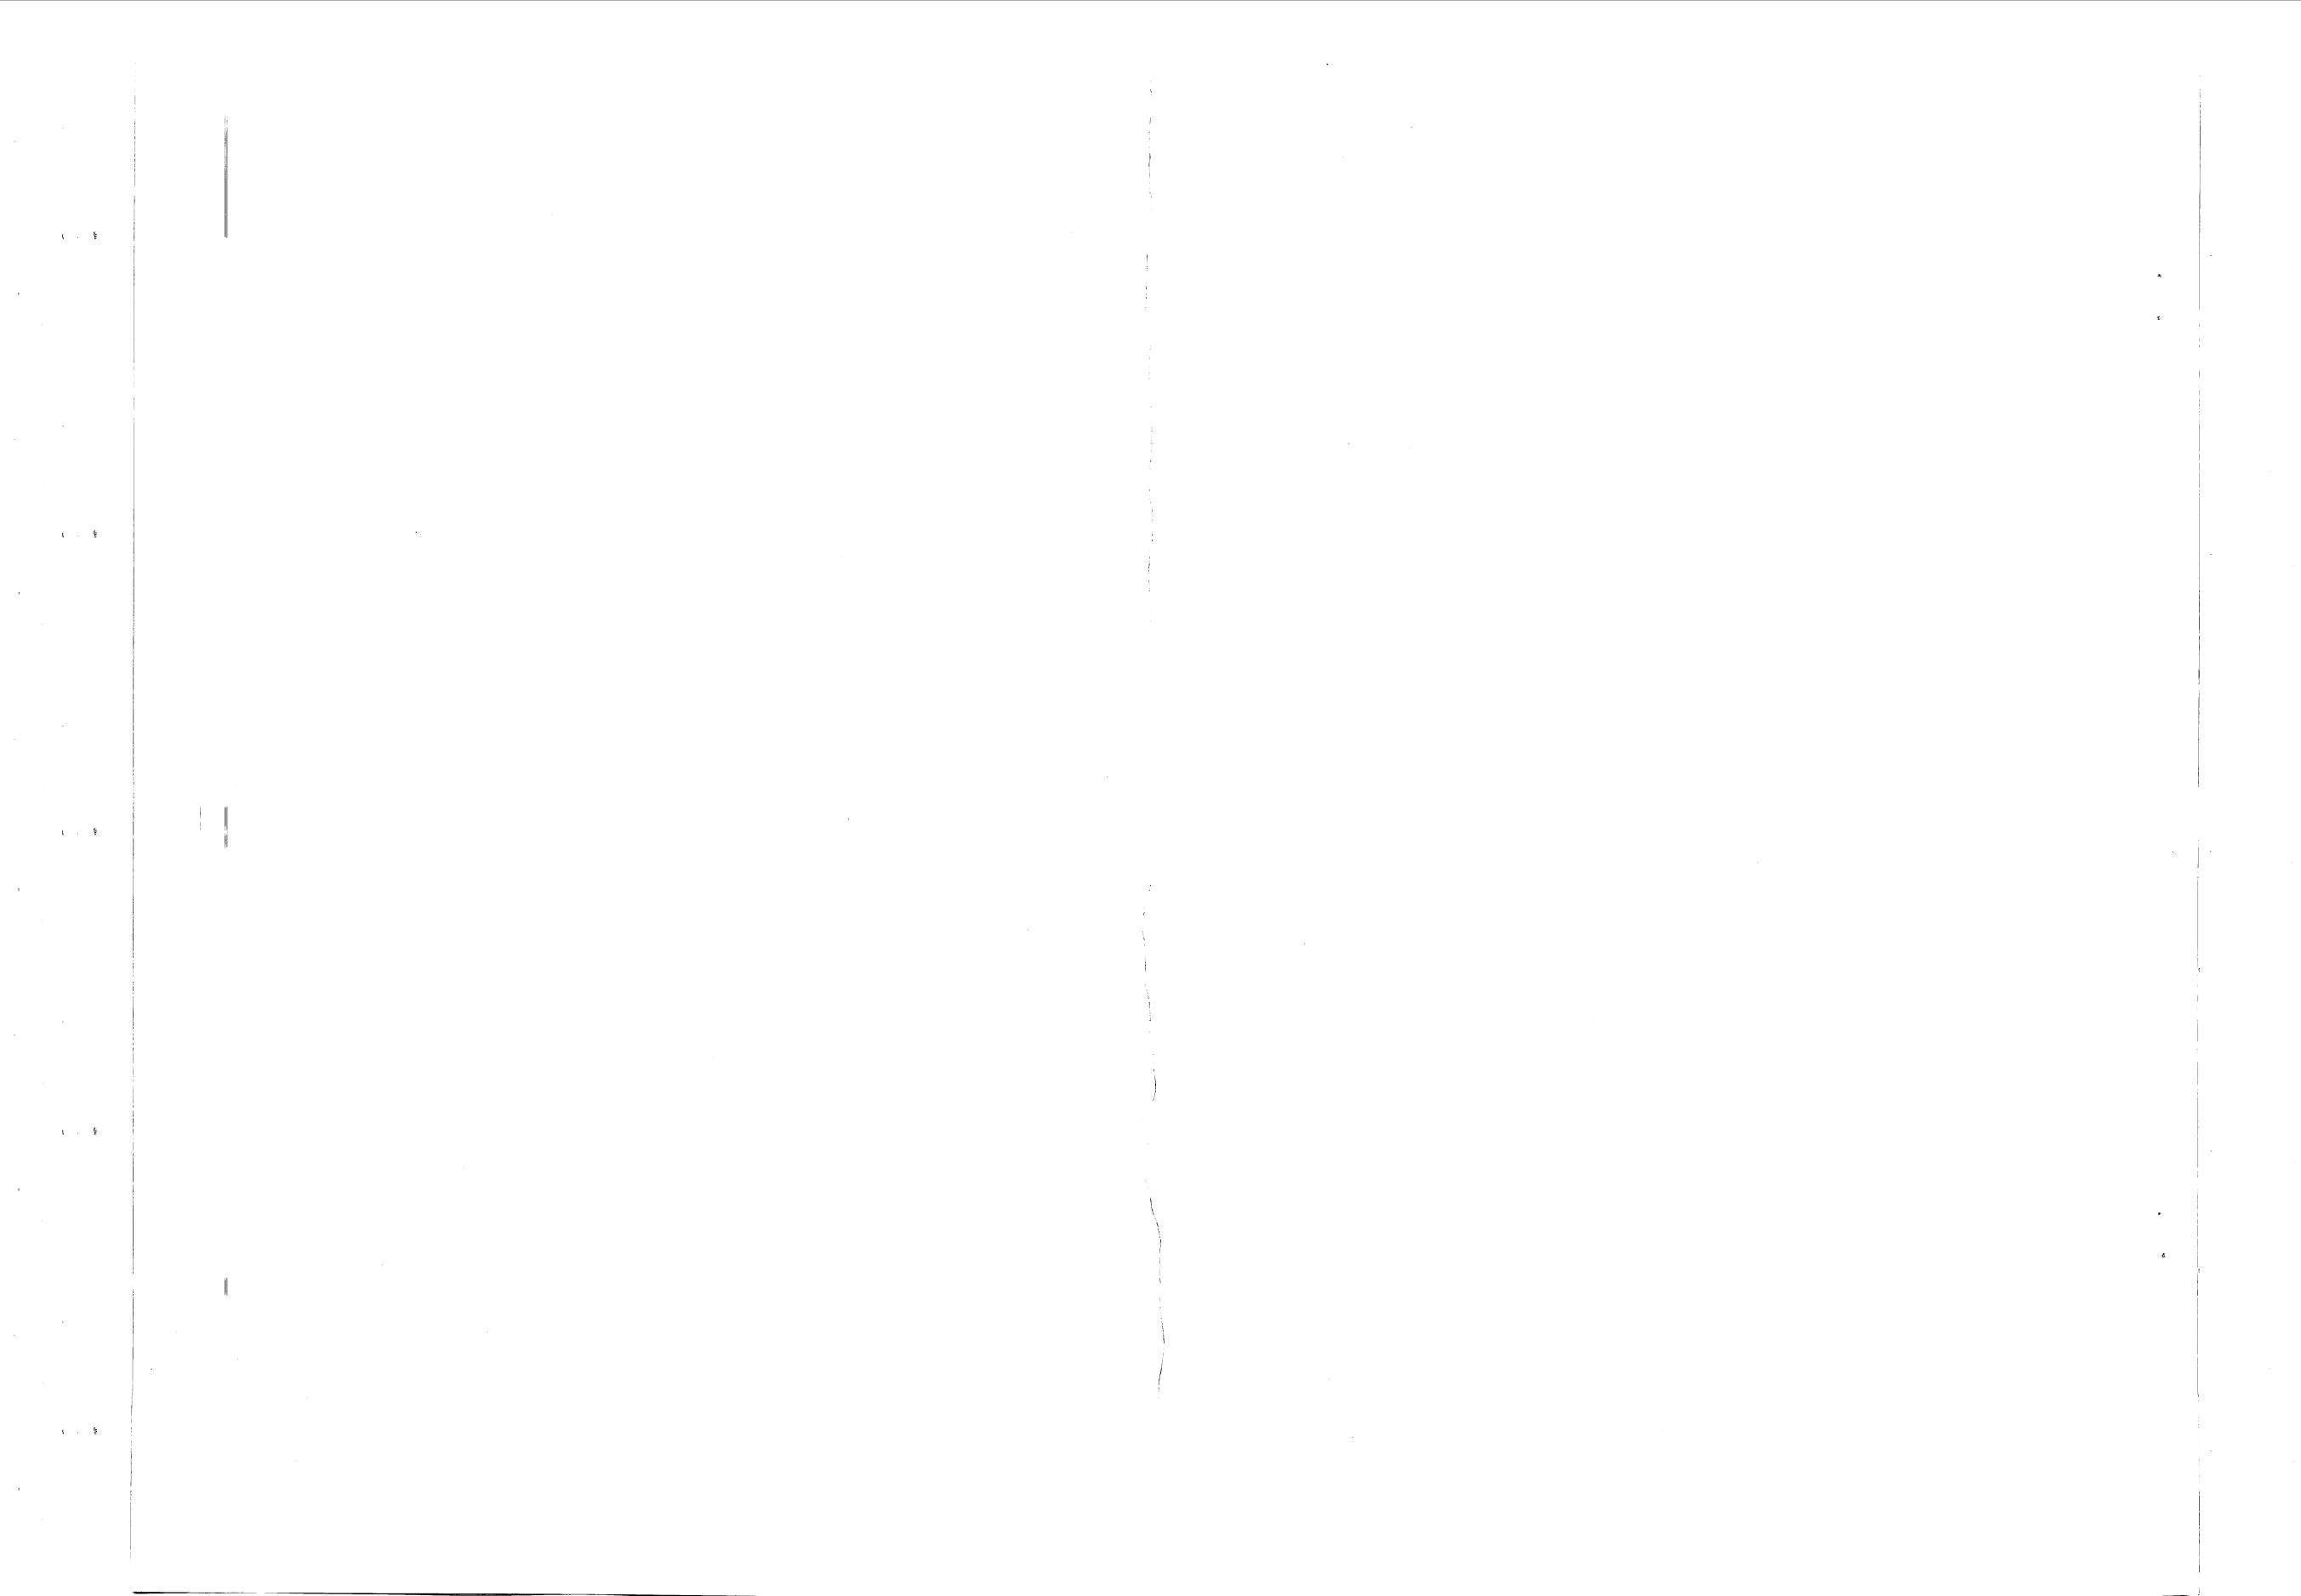
SCALE: HOTED | SPEC. 05-87-9885 | SHEET 14 OF 15

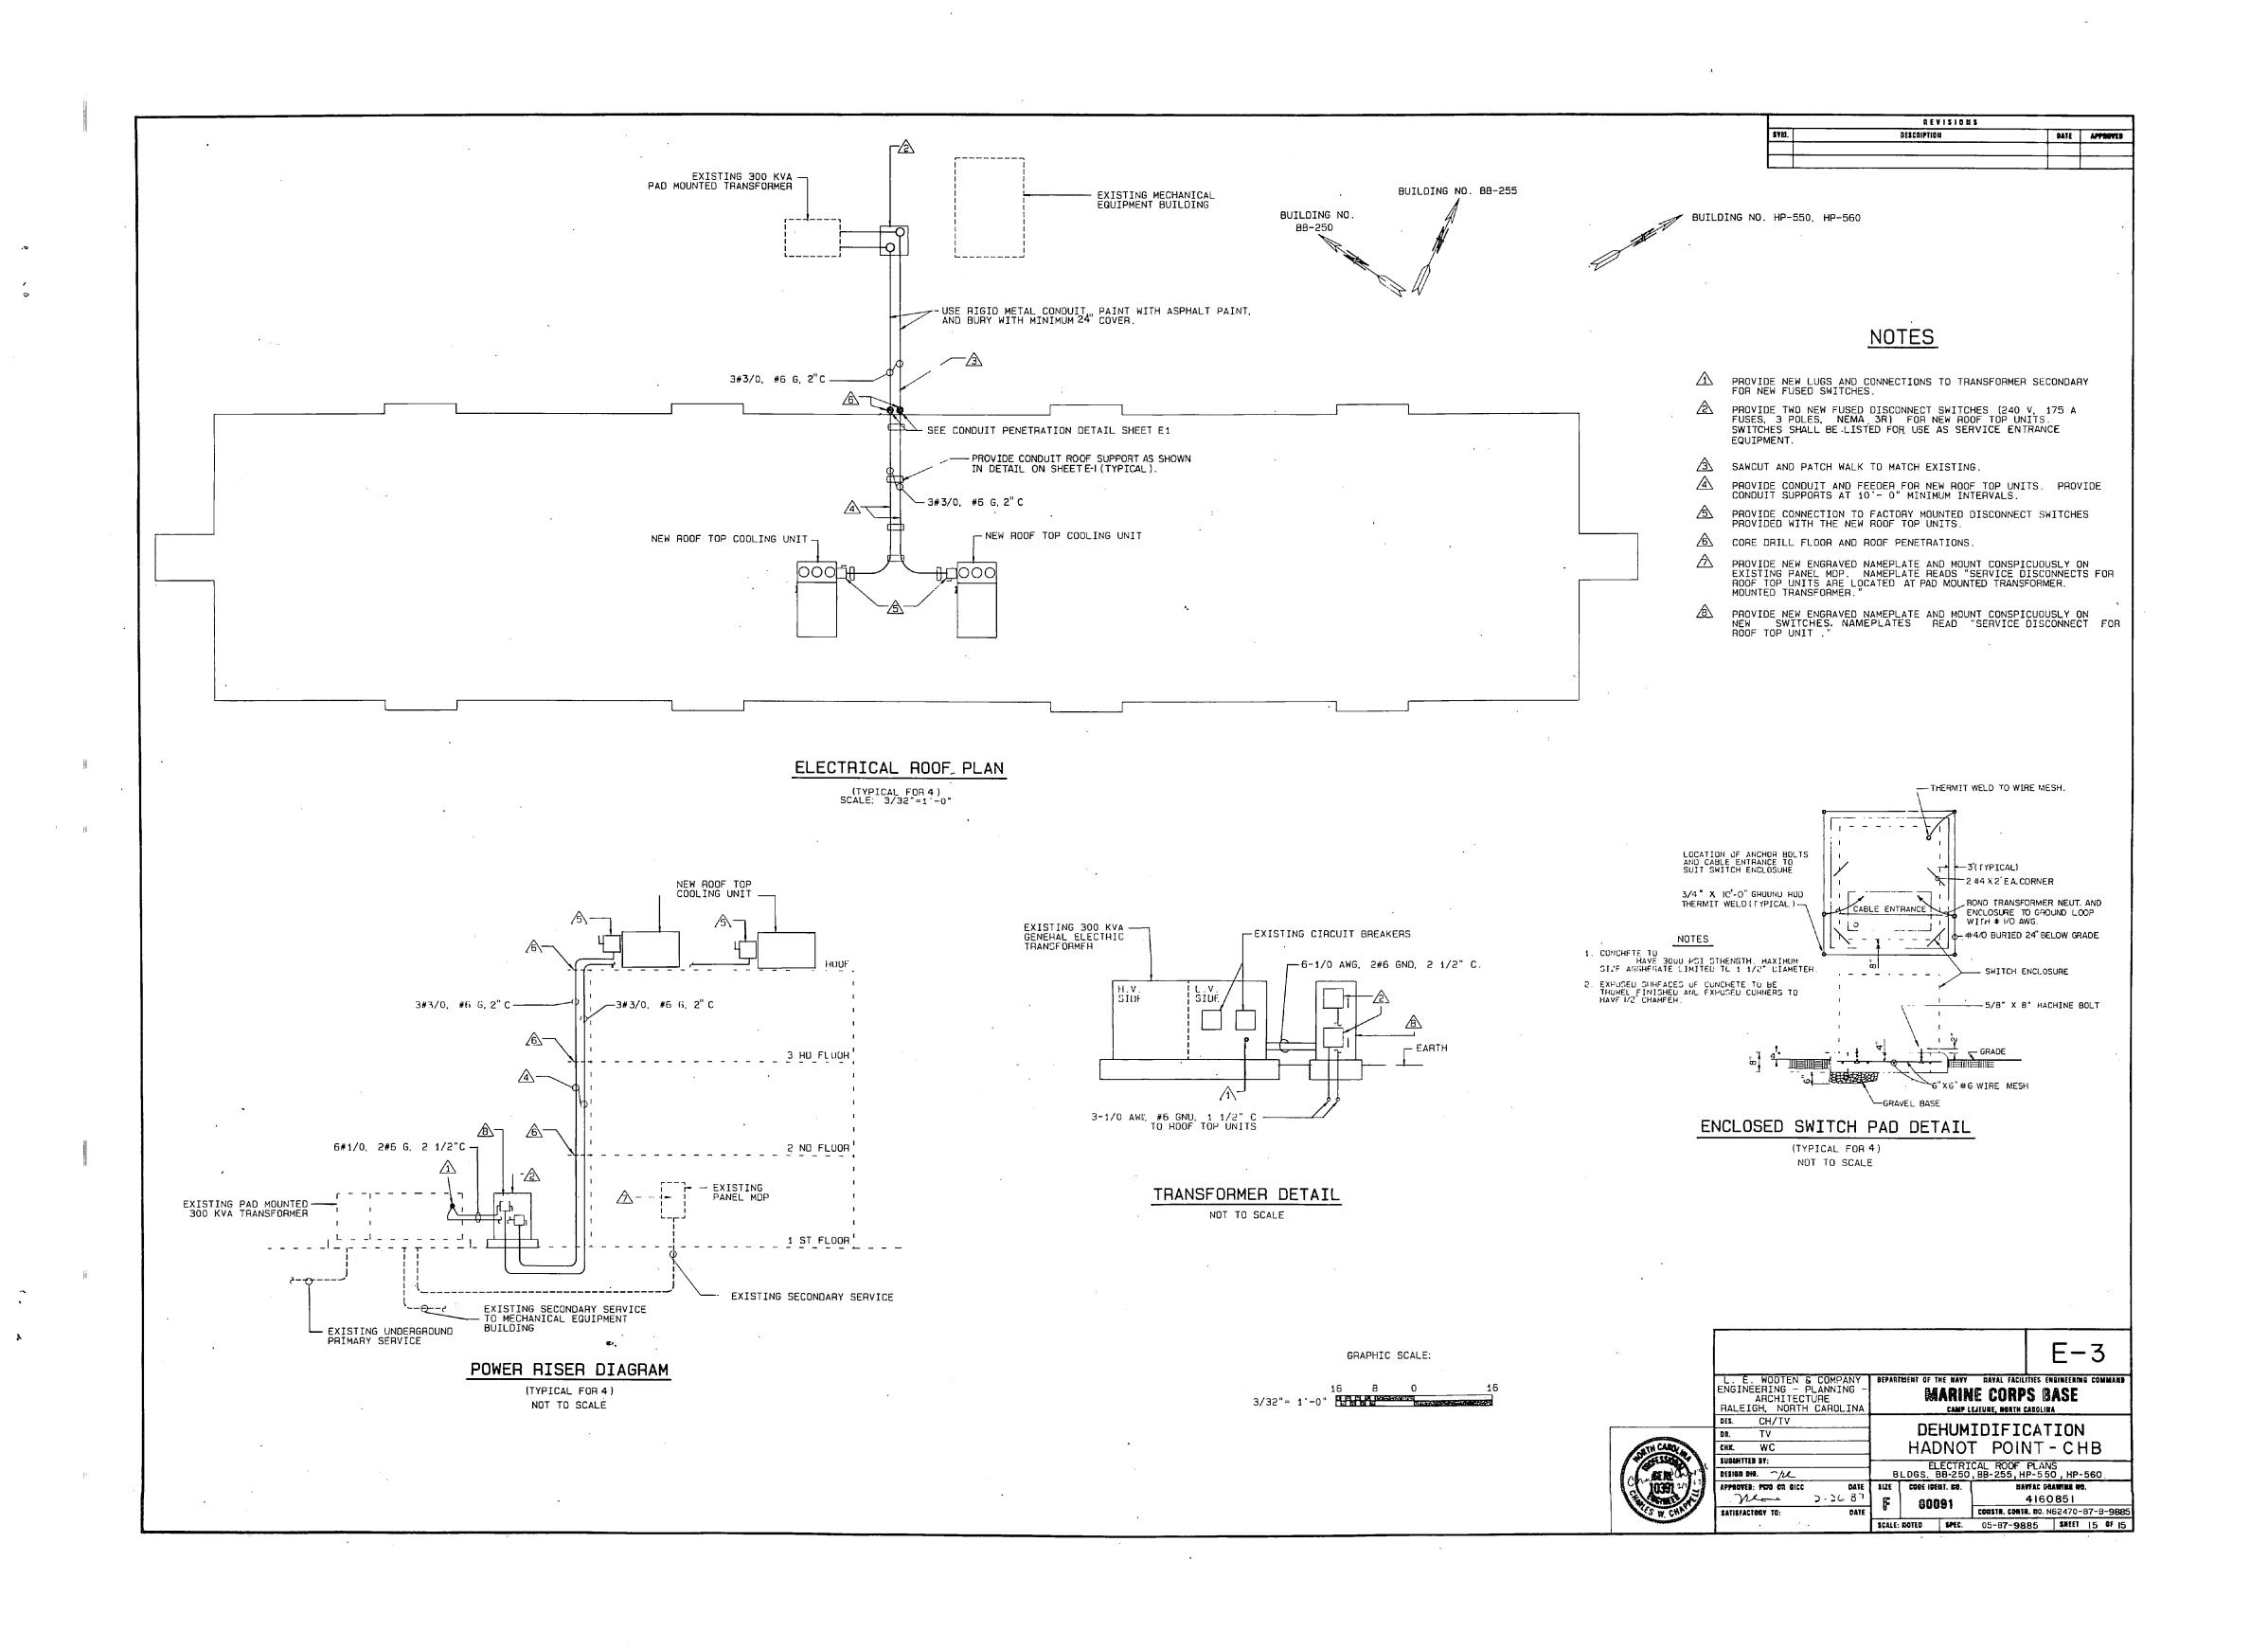
POWER RISER DIAGRAM

NOT TO SCALE

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