


INSTALL OVERHEAD DISTRIBUTION AND REPLACE CIRCUIT BREAKERS, MCB. CONSTR. CONTR. NO. N62470-85-B-6349

CAMP LEJEUNE, NC

BERKELEY MONON STATION

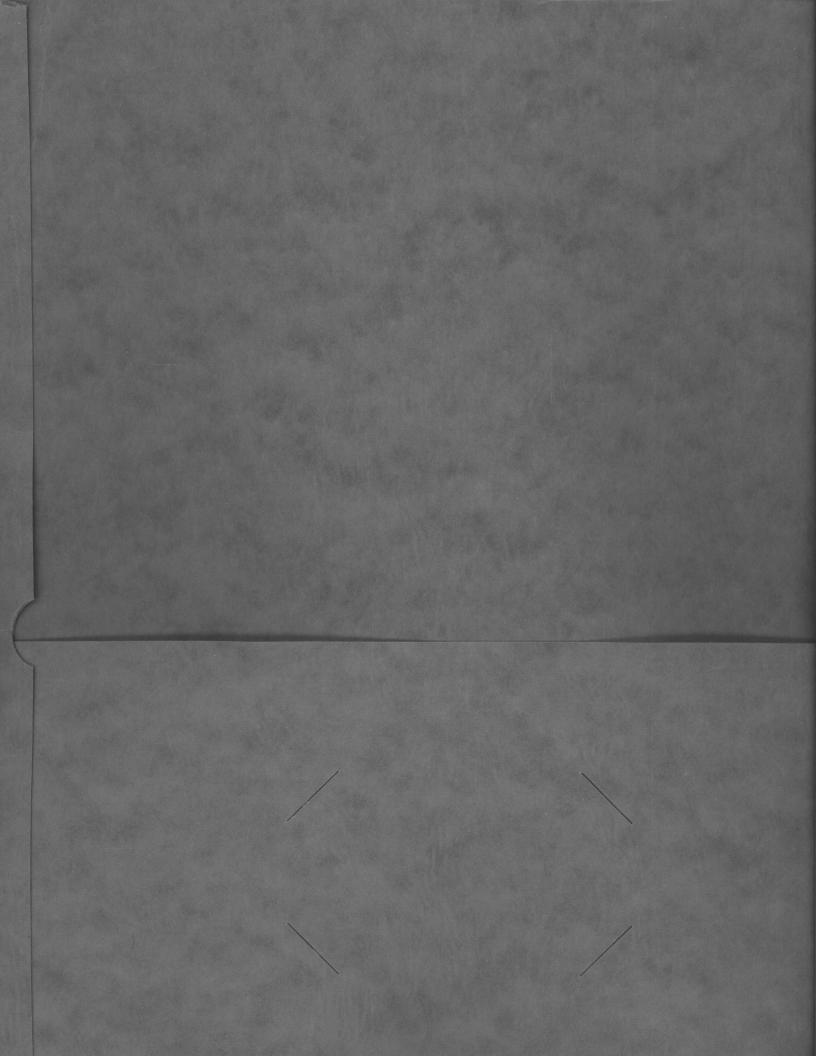

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# **Replacement Parts**

93

WED

When ordering replacement parts, please specify the part number, quantity, description of part, breaker catalog number, breaker serial number, and Square D factory order number.


ANDY YOUNG

Figure 1	Item	Description	Part Number
	1	Mechanism Assembly	730221C
	2	Charging Spring—Bottom	887637EEAA
	3	Charging Spring—Top	887637ENAA
	4	Latch Mechanism Assembly	9011045B1
	5	Latch Check Switch	25711504
	6	End Of Charge Switch	44080-588-01
	7	Main Shaft Bearing	877791
	8	Bearing Flange	877568
	9	Spring End Bushing	888005
	10	Washer	21222012
	11	Retaining Ring, 12 mm.	29915-03050
	12	Emergency Trip Assembly	44081-430-50
	13	Emergency Trip Lockout Switch	26202-01103
	14	Manual Charging Handle	44080-386-01
Figure 2	Item	Description	Part Number
	1	Auxiliary Switch, 5 Contacts	44065-038-50
	2	Auxiliary Switch, 12 Contacts	44065-038-52
	3	Operations Counter	1502403
	4	Motor Gear Box Assembly	887642A
	5	Operations Counter Operating Arm	759501
A State State	6	Indicator Connecting Link	755669

### Motors and Solenoids (Figure 2)

Item	Description	Part Number	Voltage Rating	Operating Voltage Range	Nominal Current Amperes
7	Charging	886657	24VDC		8
	Motor	886658	48VDC	36-56VDC	6
		886661	125VDC	90-140VDC	3.2
		886662	250VDC	180-280VDC	1.6
		886661	120VAC	104-127VAC	3
		886662	240VAC	208-254VAC	1.6
8	Closing	44065-389-01	24VDC	_	1.4
	Solenoid	44065-389-02	48VDC	36-56VDC	.7
		44065-389-03	125VDC	90-140VDC	.25
		44065-389-04	250VDC	180-280VDC	.15
		44065-389-05	120VAC	104-127VAC	2
	A COMPANY AND AND A	44080-590-01	240VAC	208-254VAC	1
9	Anti-Pump	8501KFD12-24VDC	24VDC	and the second	and the second second
	Relay	KUP11D55-48VDC	48VDC	36-56VDC	
		8501KFD12-110VDC	125VDC	90-140VDC	.02A
		8501KFD12-110VDC	250VDC	180-280VDC	to
		& Resistor 26160-21660			.2A
		8501KF12-120/60	120VAC	104-127VAC	
		44050-266-01	240VAC	208-254VAC	
10	Trip	44080-590-20	24VDC	14-28VDC	2
	Solenoid	44080-590-21	48VDC	28-56VDC	1
		44065-389-23	125VDC	70-140VDC	.5
		44080-590-22	250VDC	140-280VDC	.25
		44065-389-25	120VAC	104-127VAC	1.2
		44065-389-26	240VAC	208-254VAC	.6
		887191BJ	125VDC*		3

\* Special 3 amp Rating

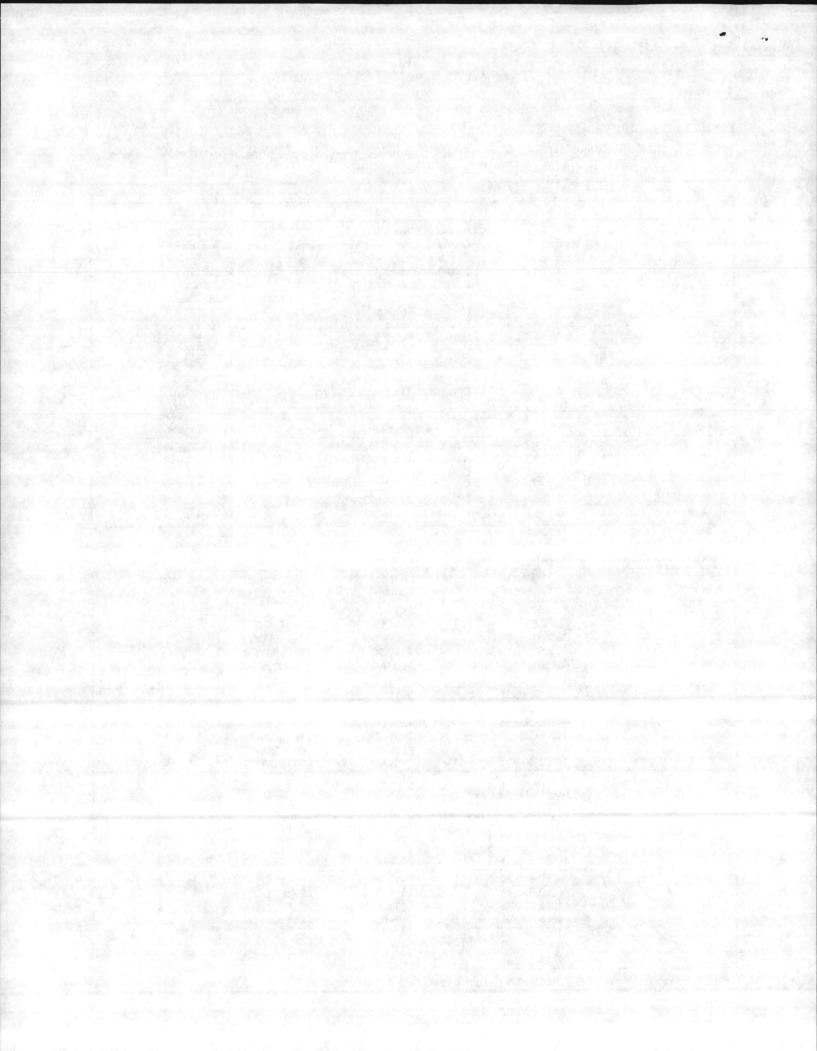

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ANDY Young

6060IM9102 December, 1991

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P.02

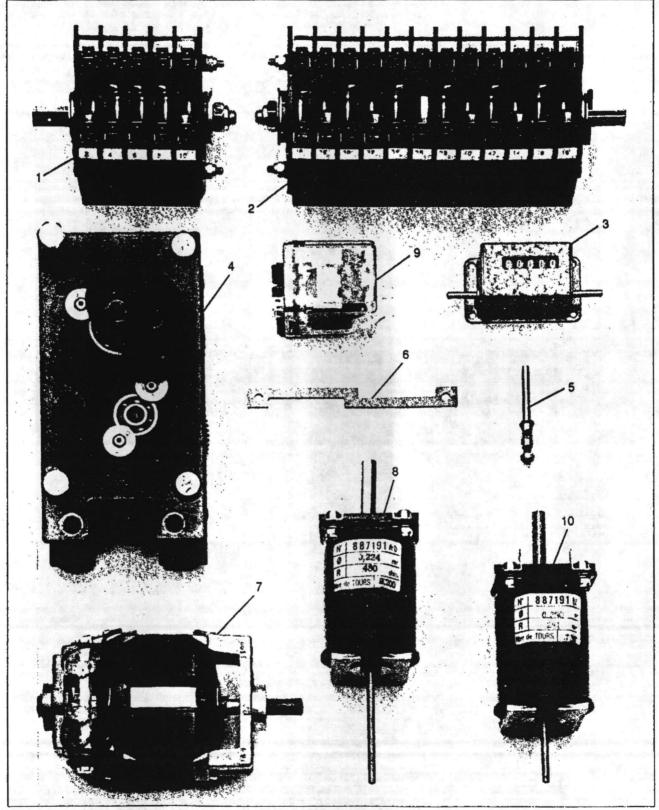
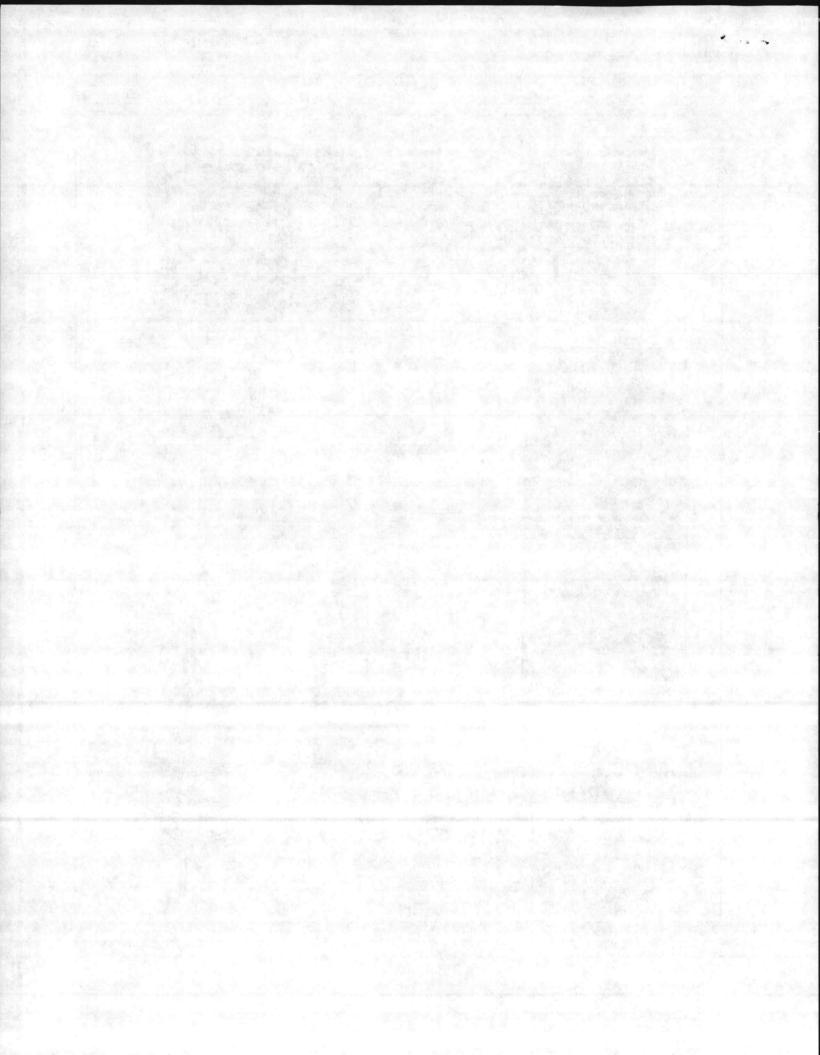


Figure 2




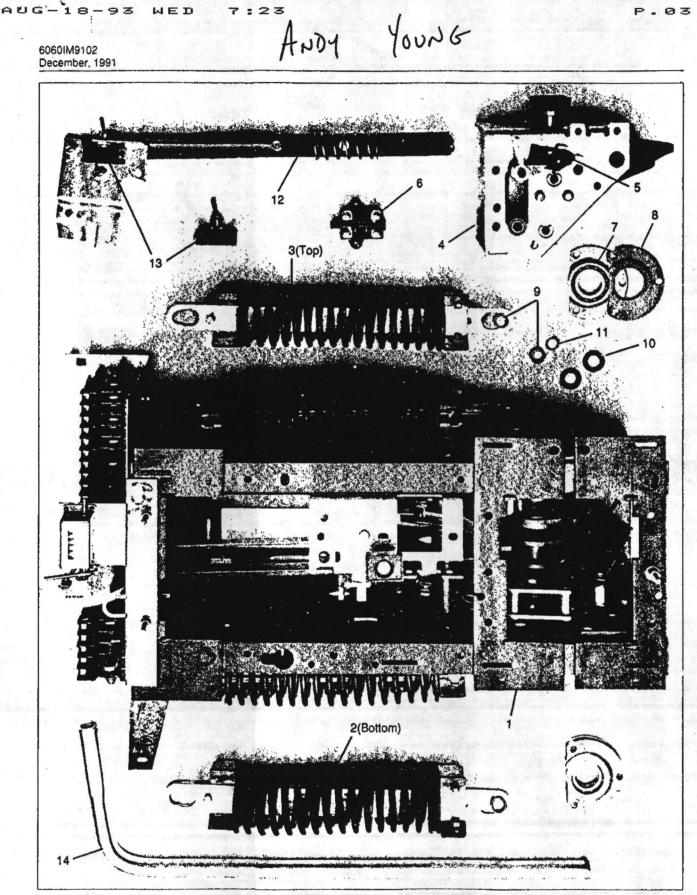


Figure 1

2-

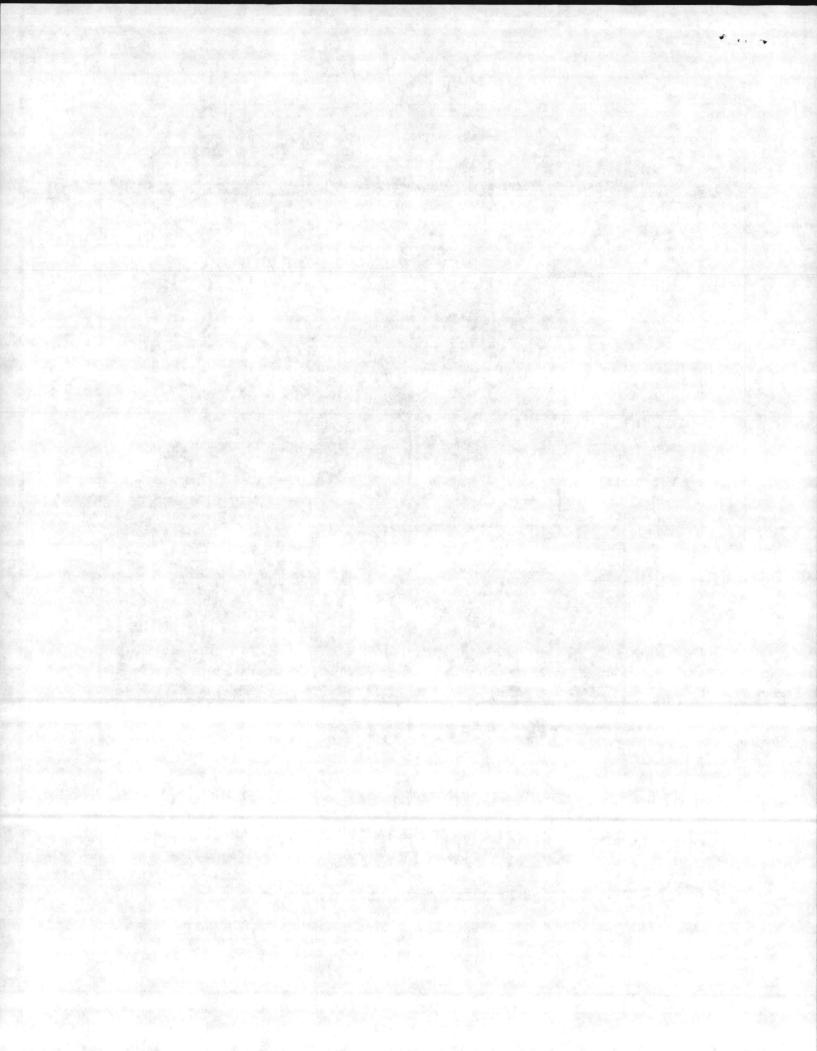

Item #14 Spec. 16302-2.15.5 Contract N62470-85-C-6349

#### SQUARE D COMPANY

#### POWER EQUIPMENT DIVISION

JOB NAME: MARINE CORPS BASE

SESCO

24578-1-14D

17-14333A

LOCATION:

CAMP LEJEUNE MARINE CORPS BASE, NC

EQUIPMENT:

FBS1061112 SUBSTATION BREAKER QUANTITY:2

CUSTOMER:

ENGINEER:

CUSTOMER ORDER #

DESIGN BRANCH, PUBLIC WORKS DIVISION

SQUARE D FIELD OFFICE: CHARLOTTE, NC

FACTORY ORDER:

HQS. ENG .:

DATE:

and all bet states and the


November 22, 1985

J. WAGGENER/R. COIL

BERKELEY MANOR 61 BREAKER Nos, 13 \$14.

and all and the second second second

17-14333-SFB1-00 PAGE 1

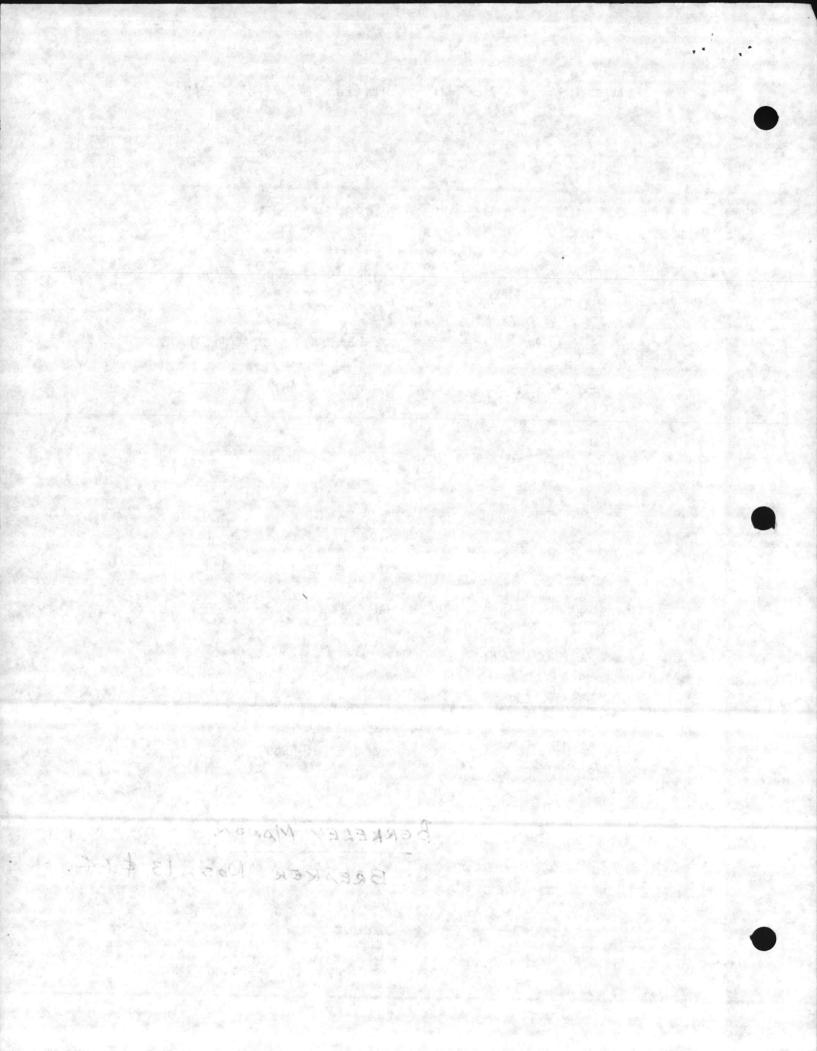

#### DRAWING INDEX

A17-14333-SFB1-00 TITLE PAGE

DRAWING INDEX

SPECIAL NOTES

BILL OF MATERIALS


D17-14333-SFB1-01 ELEVATION VIEWS

- D17-14333-SFB1-02 C. T. CONTROL SCHEMATIC
- D17-14333-SFB1-03 BREAKER CONTROL SCHEMATIC

A17-14333-SFB1-04 CIRCUIT BREAKER NAMEPLATE


- A17-14333-SFB1-05 CURRENT TRANSFORMER NAMEPLATE
- A17-14333-SFB1-06 BUSHING DRAWING
- A17-14333-SFB1-07 C. T. EXCITATION CURVES
- A17-14333-SFB1-08 O.C. TIME CURRENT CHARACTERISTIC CURVES
- C17-14333A-950 WIRING DIAGRAM

17-14333-SFB1-00 PAGE 2

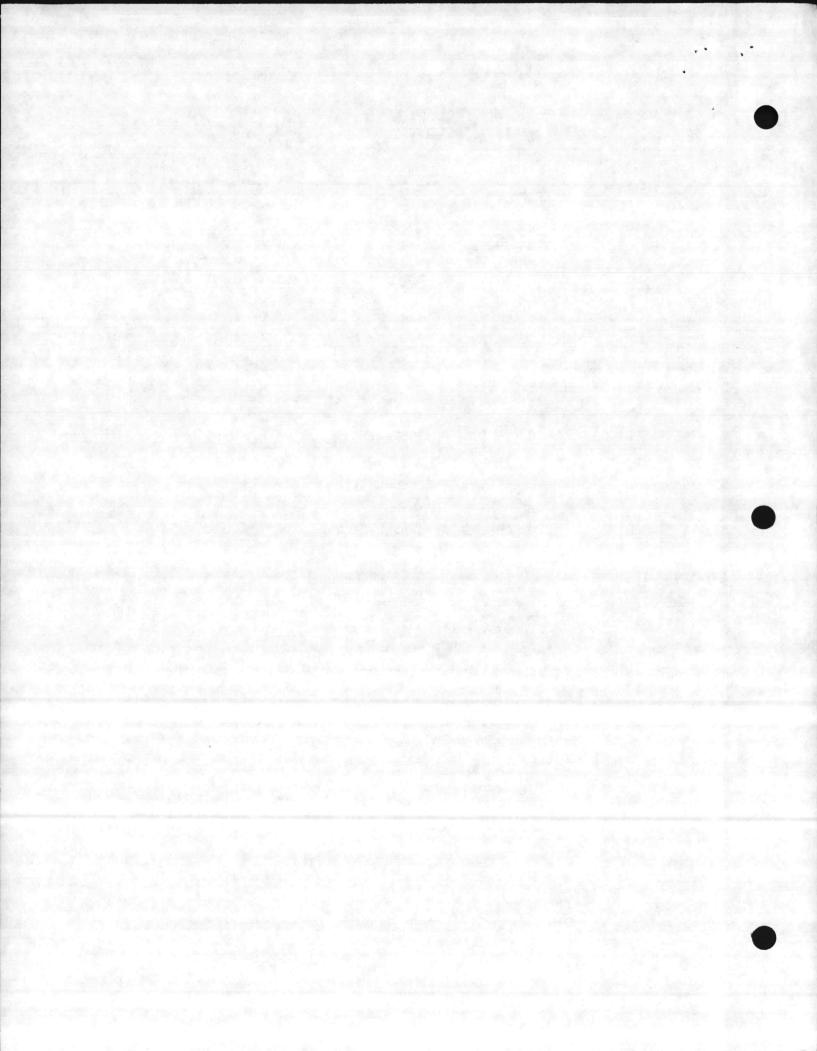


#### SPECIAL NOTES

- 1. Provide 1 set of spare parts to include the following:
  - QTY:
  - 1 SF6 bottle rated 600A, 15.5 KV, 110 KV BIL, part #758962B.
  - 2 Bushings, cat. #D44080-099-01.
  - 2 Current transformers, cat. #311-601.
- 2. Provide cut-out for type ITE-79M, reclosing relay, per breaker.
- 3. Provide additional 69 switch to operate only on emergency trip and lockout.
- 4. Breaker to be shipped at 9'-4" height.

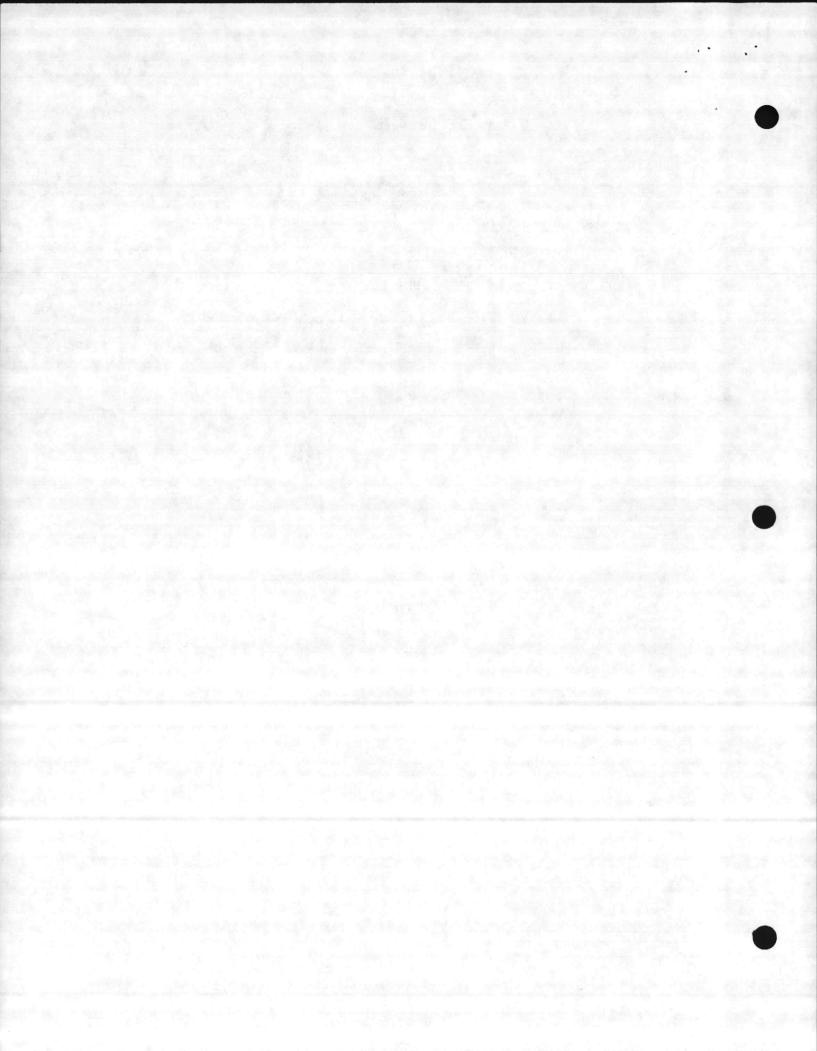


EQUIPMENT SOURCE CODES:

- 1. SQUARE D COMPANY
- 2. ANDERSON (SQUARE D COMPANY)
- 3. ELECTROMAGNETICS INDUSTRIES (SQUARE D COMPANY)
- 4. SORGEL (SQUARE D COMPANY)
- 5. AGASTAT (AMERACE CORPORATION)
- 6. BUSSMAN MFG. DIVISION
- 7. CALVERT COMPANY
- 8. DAYTON THERMOSTAT
- 9. EDWARDS
- 10. ELECTROSWITCH CORPORATION
- 11. EXIDE POWER SYSTEMS DIVISION
- 12. FREQUENCY TECHNOLOGY, INCORPORATED TDC DIVISION
- 13. GENERAL ELECTRIC COMPANY
- 14. GOULD, INC.
- 15. GRAYBAR ELECTRIC COMPANY, INCORPORATED
- 16. G & W ELECTRIC SPECIALTY COMPANY
- 17. HEVI-DUTY ELECTRIC
- 18. MC GRAW-EDISON COMPANY
- 19. MULTI-AMP CORPORATION
- 20. NIAGARA TRANSFORMER CORPORATION
- 21. NIFE INCORPORATED
- 22. OHIO BRASS COMPANY
- 23. PLM PRODUCTS
- 24. PORCELAIN PRODUCTS
- 25. RTE CORPORATION
- 26. SANGAMO ELECTRIC
- 27. S & C ELECTRIC COMPANY
- 28. STORED ENERGY SYSTEMS (SENS)
- 29. SUPERIOR SWITCHBOARD AND DEVICES COMPANY
- 30. THERMO-O-DISC
- 31. WESTINGHOUSE ELECTRIC CORPORATION
- 32. SCIENTIFIC COLUMBUS (ESTERLINE CORPORATION)
- 33. CUTLER-HAMMER
- 34. WESCHLER INSTRUMENTS
- 35. FILNOR, INC.
- 36. POTTER & BRUMFIELD
- 37. BASLER ELECTRIC COMPANY
- 38. BROWN BOVERI
- 39. C & D
- 40. BODENDIECK TOOL DIV OF SQUARE D

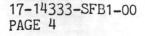




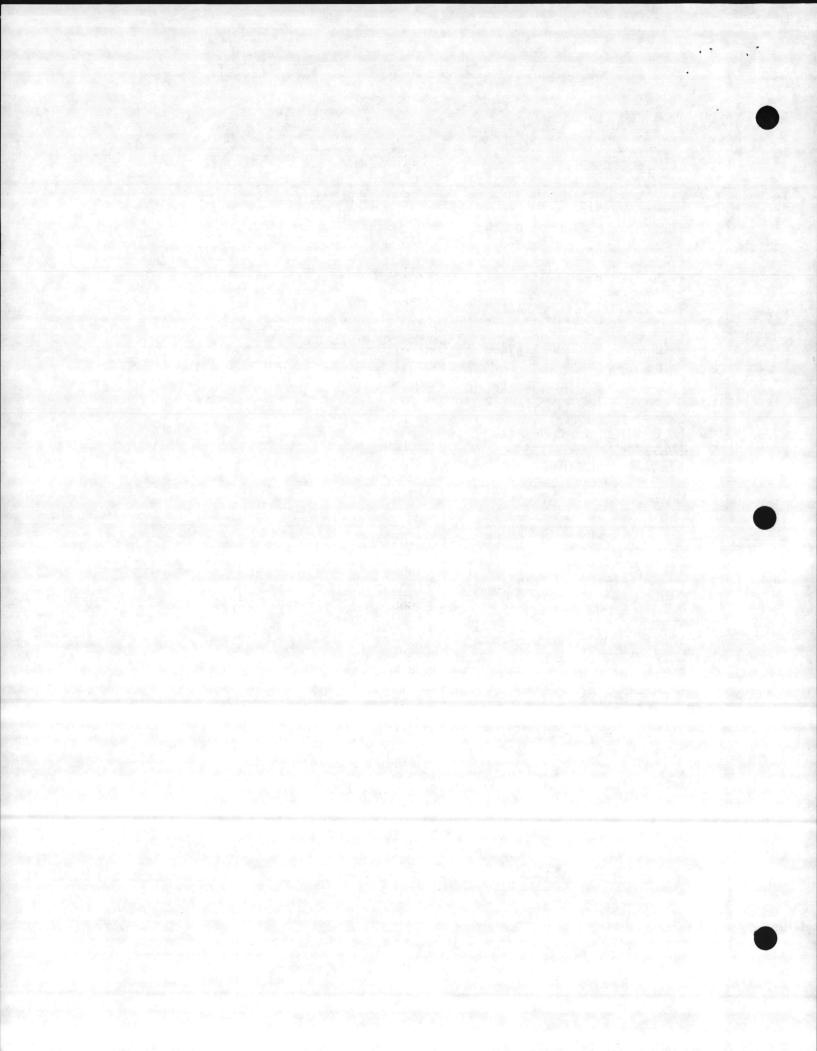

I T E M	Q T Y		O U R C E	QUANTITIES PER BREAKER
A	1	52	1	Fluarc substation circuit breaker, type FBS rated 15.5 kV, 600 amperes continuous, 12 KA interrupting, Cat. #FBS1061112.
В	6	BUSHING	3	Enclosure current transformer bushing, Cat. #D44080-099-01 .
С	2	8H,8AC	29	Fusible control power disconnect, knife type, Cat. #21330F.
D	1	CS	10	Breaker control switch, Cat. #2444D.
E	1	RIL	1	Indicating lamp, 240VAC, resistor type with red color cap and nameplate marked "CLOSED", Cat. #9001-KP25-R6.
F	1	GIL	1	Indicating lamp, 240VAC, resistor type with green color cap and nameplate marked "OPEN" Cat. #9001-KP25- G6.
G	6	CT	3	Bushing current transformer 600:5 multi-ratio, C 100 relaying accuracy, rated 15.5 kV, 110 kV BIL as installed on bushings, Cat. #311-601.
Н	6	TB	13	Six circuit shorting terminal block, cat. #EB27A06S.
I	1	50/51 A,B,C	38	Type ITE-51E overcurrent relay, extremely inverse time characteristic, 4-12 amp tap, with 8-240 instantaneous trip, cat. #223T3311.
J	1	50/51 G	38	Type ITE-51E overcurrent relay, extremely inverse time characteristic, 0.5-2 amp tap, with 0.5-20 instantaneous trip, cat. #223S3114.
К	1	79C0	33	Recloser cut-off switch, DPST, Cat. #7402K4.
L	3	АМ	1	AC ammeter, 5 amp rating, 0-600 amp scale, cat. #2830- 1161-LSSJ.
М	1	VM	1	AC voltmeter, 250 volt movement, with 0-13 kV scale, cat. #2830-1041-PZUY.


17-14333-SFB1-00 PAGE 5

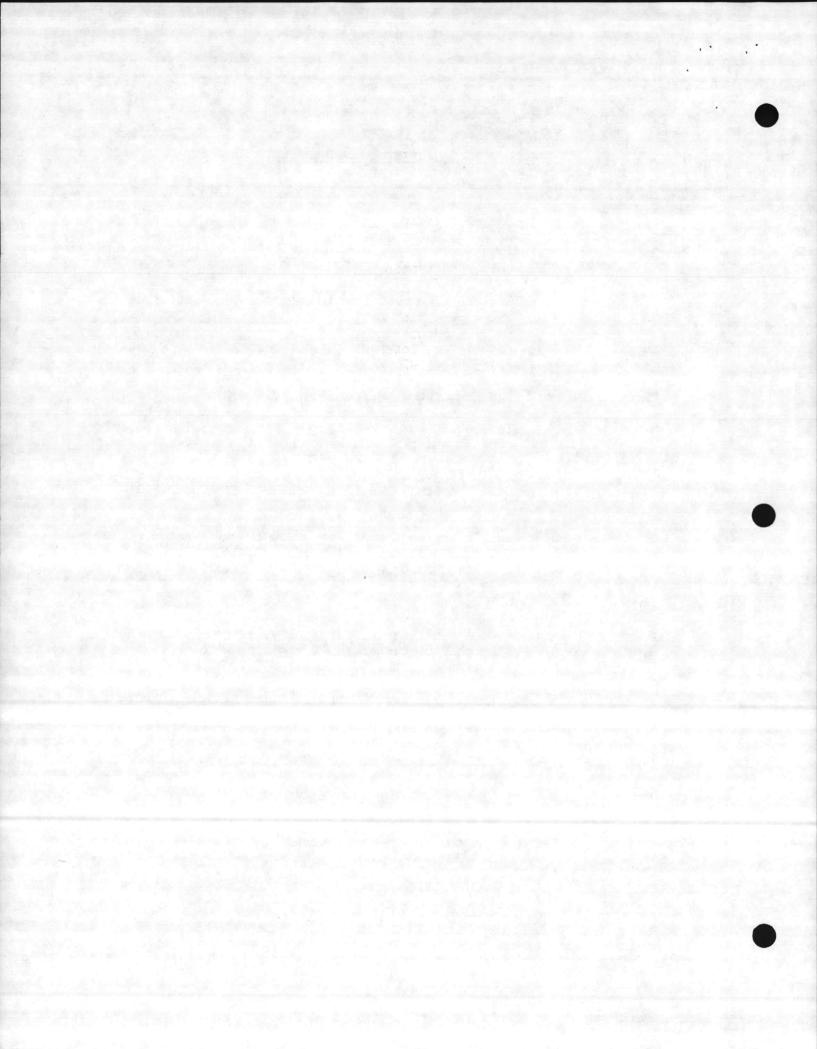



I T E M	Q T Y		S O U R C E	QUANTITIES PER BREAKER
N	1	CTU	1	Capacitor trip unit, rated input 240 VAC, cat.# ST200.
0	6	CONNECTOR	2	Type DSC, bronze stud connector to cable, cat. #DSC- 11025-12-3.
Ρ	1	WHDM	13	Watthour demand meter, type DSM-65, rated 120 VAC, 4 wire Y, 3 phase. Watthour constant of 1.8, with 15 minute time interval, PT ratio 12.47 kV/240, CT ratio 600/5, cat. #700X67G9.

17-14333-SFB1-00 PAGE 6


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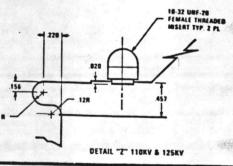

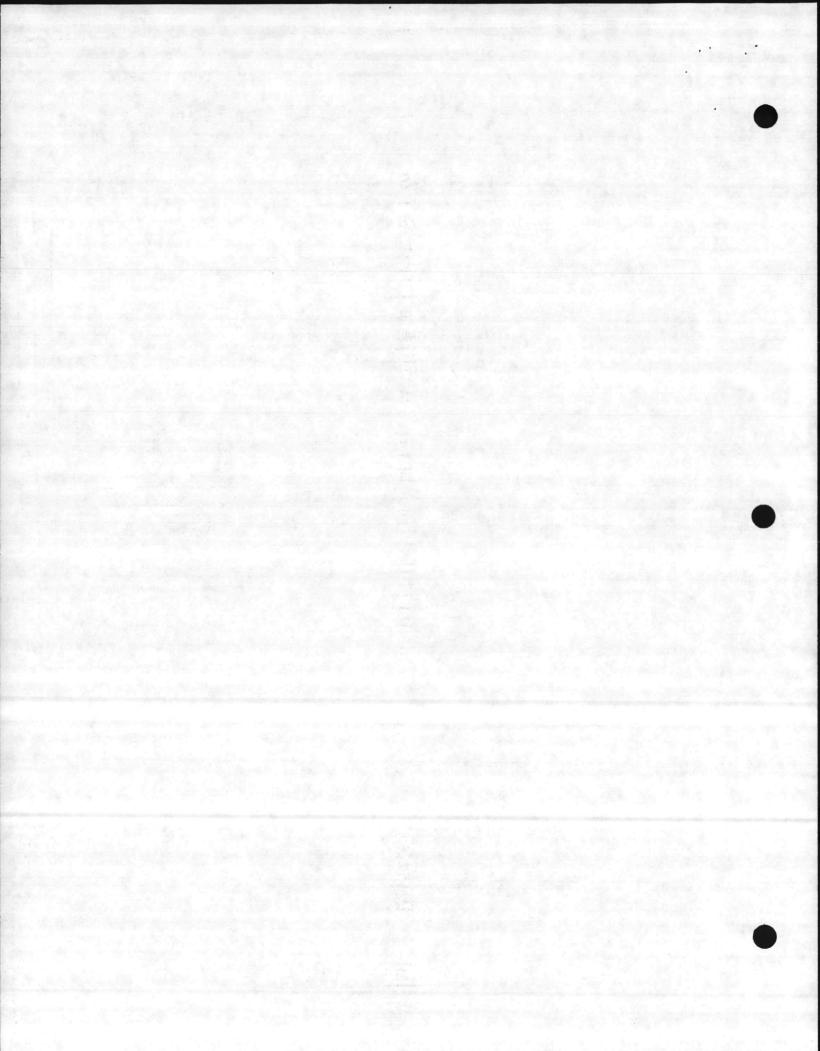
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	METER ACC.		SHORT TIME TI	HERMAL 60 X RATED CL 600:5 MR	A DECEMBER OF STREET, STRE
		RN .0015 OHM AT 25°C OR 1.5 30°C AMB DATE MFG		X4 X3 X2 XI	
•	RATIO TERMINAL	and the second	00:5 250:5 300:5 4-X5 X3-X4 X2-X4	400:5 450:5 500:5 60 x1-x4 x3-x5 x2-x5 x1	00:5 -X5
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DEEP (	OI, -02, 5, -07) RATING (A)	DEEP (-O3) EI CAT. NO. SD-15-110-1200	0) DIM. 110KV	A 34.99	B 14.19	C 20.80	3.00	8.80	8.25	5.954	3.125	3.125	1 1/8-12	t
DEEP (05,-06 PART NO. D44080-099-01	RATING (A) 600/1200	DEEP (-O3) EI CAT. NO. SD-15-110-1200 SD-25-125-1200	0 ) 110KV 125KV	A 34.99 37.57	B 14.19 16.19	C 20.80 21.38	3.00	8.80 9.38	8.25 8.25	5.954 5.954	3.125	3.125	1 1/8-12	ļ
DEEP(05,-06 PART NO. D44080-099-01 D44080-099-02	COI, -02, 5, -07) RATING (A) 600/1200 600/1200 1200	DEEP (-O3) EI CAT. NO. SD-15-110-1200 SD-25-125-1200 SD-38-150-1200	0) DIM. 110KV 125KV 150KV	A 34.99 37.57 45.07	B 14.19 16.19 22.07	C 20.80 21.38 23.00	3.00 3.00 3.00	8.80 9.38 11.00	8.25 8.25 10.50	5.954 5.954 8.500	3.125 3.125 5.370	3.125 3.125 4.370	1 1/8-12 1 1/8-12 1 1/2-12	
DEEP ( -05,-06 PART NO. D44080-099-01 D44080-099-02 D44080-099-03	COI, -O2, 5, -O7) RATING (A) 600/1200 600/1200 1200 3000	DEEP (-O3) EI CAT. NO. SD-15-110-1200 SD-25-125-1200 SD-38-150-1200 SD-15-110-3000	0) DIM. 110KV 125KV 150KV 110KV	A 34.99 37.57 45.07 37.49	B 14.19 16.19 22.07 15.70	C 20.80 21.38 23.00 21.80	3.00 3.00 3.00 4.00	8.80 9.38 11.00 8.80	8.25 8.25 10.50 9.88	5.954 5.954 8.500 7.710	3.125 3.125 5.370 4.880	3.125 3.125 4.370	1 1/8-12 1 1/8-12 1 1/2-12	
DEEP ( -05,-06 PART NO. D44080-099-01 D44080-099-02 D44080-099-03 D44080-099-04 D44080-099-05	OI, -02, 5, -07) RATING (A) 600/1200 600/1200 1200 3000 2000	DEEP (-O3) EI CAT. NO. SD-15-110-1200 SD-25-125-1200 SD-38-150-1200 SD-15-110-3000 SD-38-150-2000	О ) 110КV 125КV 150КV 110КV 150КV	DE E A 34.99 37.57 45.07 37.49 46.88	B 14.19 16.19 22.07 15.70 22.88	C 20.80 21.38 23.00 21.80 24.00	3.00 3.00 3.00 4.00 3.00	8.80 9.38 11.00 8.80 12.00	8.25 8.25 10.50 9.88 13.65	5.954 5.954 8.500	3.125 3.125 5.370	3.125 3.125 4.370	1 1/8-12 1 1/8-12 1 1/2-12 2 7/8-12	
DEEP( -05,-06 PART NO. D44080-099-01 D44080-099-02 D44080-099-03 D44080-099-04	COI, -O2, 5, -O7) RATING (A) 600/1200 600/1200 1200 3000	DEEP (-O3) EI CAT. NO. SD-15-110-1200 SD-25-125-1200 SD-38-150-1200 SD-15-110-3000	0 DIM. 110KV 125KV 150KV 110KV 150KV 110KV	A 34.99 37.57 45.07 37.49	B 14.19 16.19 22.07 15.70	C 20.80 21.38 23.00 21.80	3.00 3.00 3.00 4.00	8.80 9.38 11.00 8.80	8.25 8.25 10.50 9.88	5.954 5.954 8.500 7.710	3.125 3.125 5.370 4.880	3.125 3.125 4.370 5.500	1 1/8-12 1 1/8-12 1 1/2-12 2 7/8-12 2 - 12	

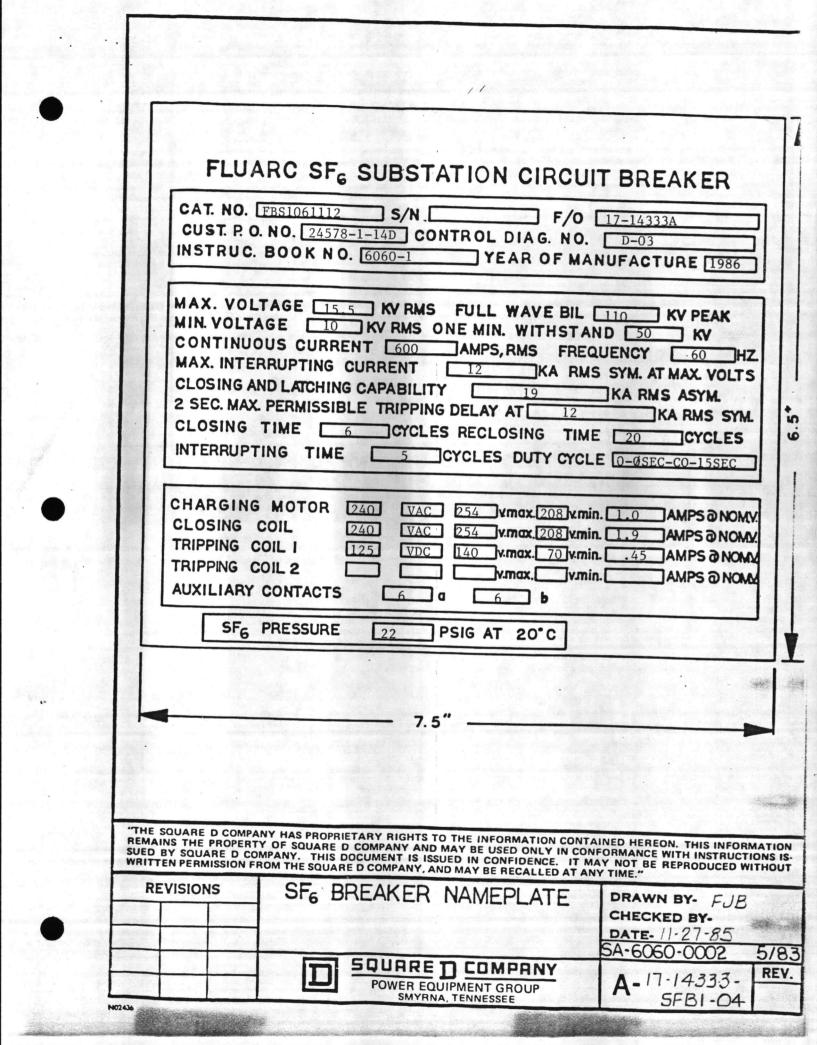Q.C.	TEST CHART	PARTIAL D	ISCHARGE TEST VALUES	I MIN. WITHSTAND
SYSTEM VOLTACE (KV)	PART NUMBER	MAXIMIM TEST VOLTAGE (KV)	MINIMUM VOLTAGE AT WILCH EXTINCTION (SPICOC) MUST OCCUR (KV)	TEST VALUE TO BE APPLIED FOR ONE MINUTE WITH OUT BREAKDOWN (EV)
15.5	144080-099-01	17.9	9.8	50,00
25.8	D44080-099-0?	. 29.8	16.4	60.00
38	D44080-099-03	43.9	24.1	80.00
15.5	D44080-099-04	17.9	9.8	50.00
38	144080-099-05	43.9	24.1	80.00
15.5	D44080-099-06	17.9	• 9.8	50.00
38	D44080-099-07	43.9	24.1	80.00

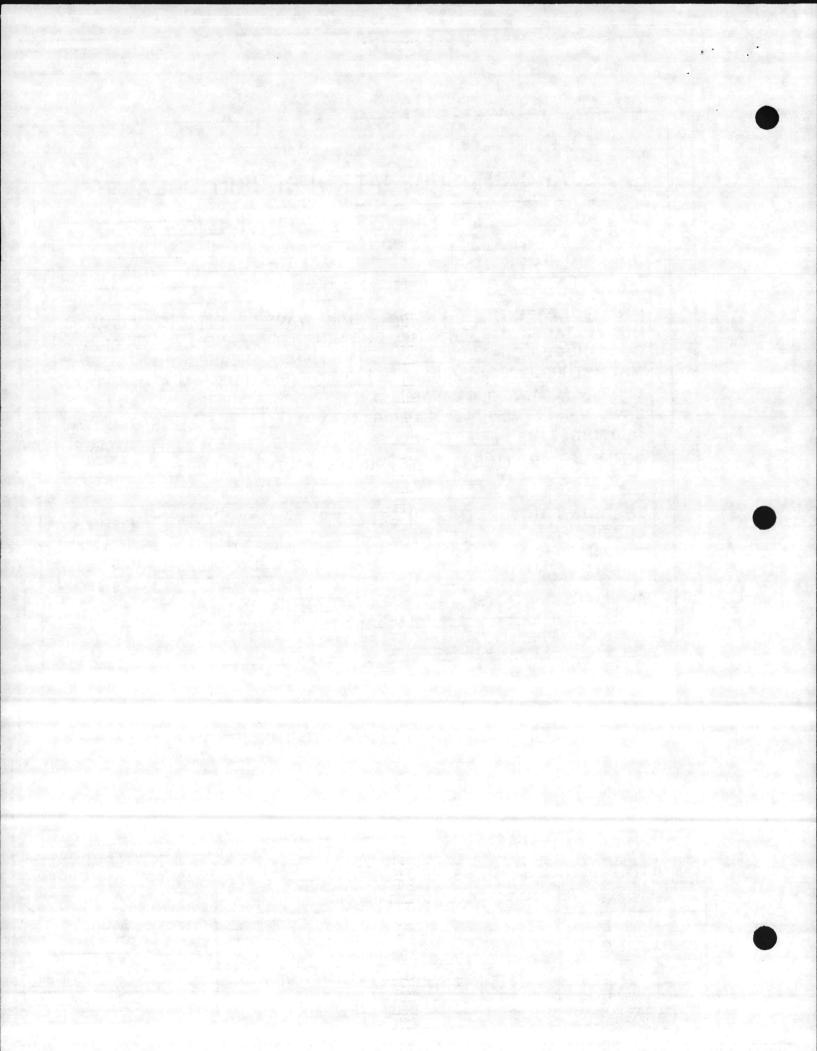


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"THE SQUARE D COMPANY HAS PROPRIETARY RIGHTS TO THE INFORMATION CONTAINED HEREON. THIS INFORMATION REMAINS THE PROPERTY OF SQUARE D COMPANY AND MAY BE USED ONLY IN CONFORMANCE WITH INSTRUCTIONS IS SUED BY SQUARE D COMPANY. THIS DOCUMENT IS ISSUED IN CONFIDENCE. IT MAY NOT BE REPRODUCED WITHOUT WRITTEN PERMISSION FROM THE SQUARE D COMPANY, AND MAY BE RECALLED AT ANY TIME."

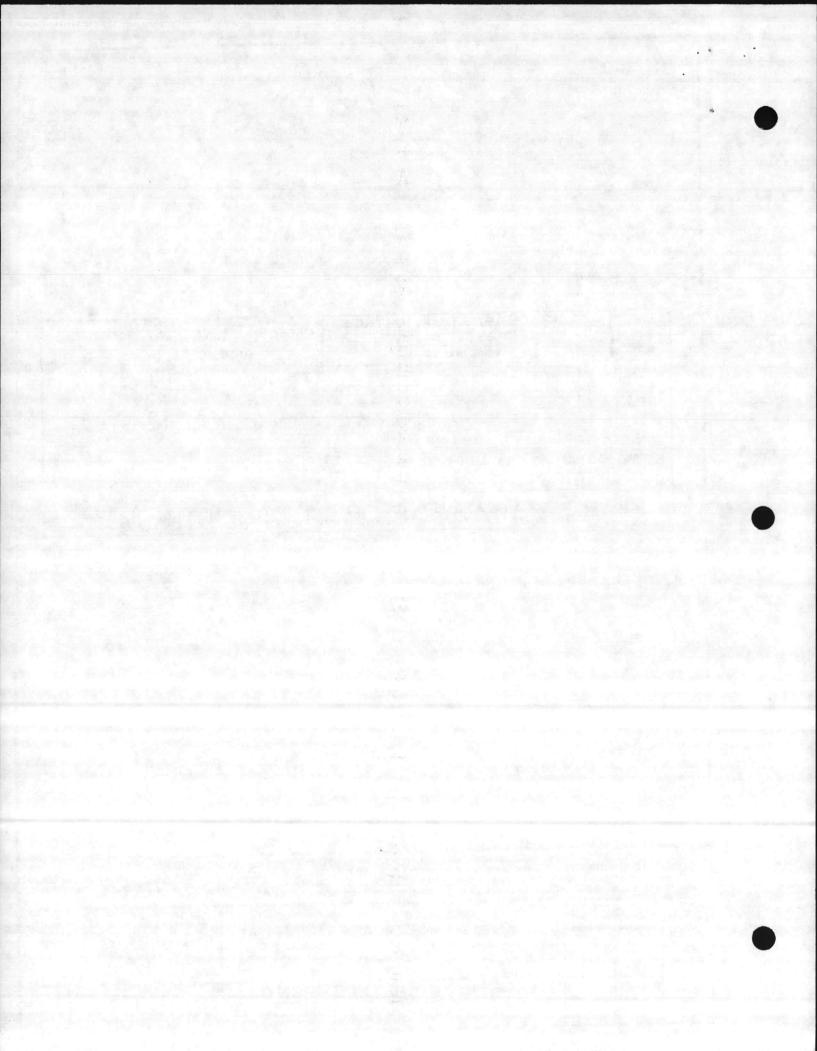REVISIONS	SF6 CONDENSER BUSHING	DRAWN BY- FUB CHECKED BY-JUL DATE- 11-27-85
		SD44080-099 REV. F
	POWER EQUIPMENT GROUP	A-17-14333 - REV. SFB1-06


Frowline N2976:



# CAT. NO. 311-601

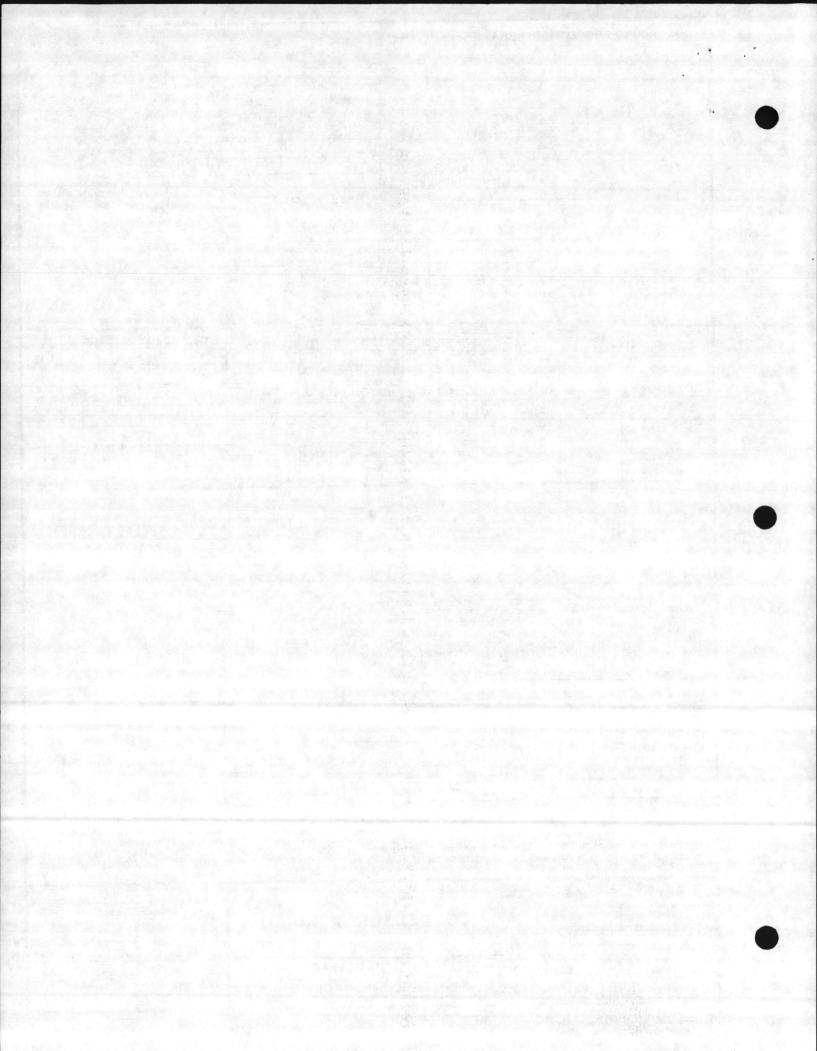
TERMINALS	CURRENT RATING (amperes)	DCR @ 25°C
×2 · ×3	50:5	.015
x:1x2	100:5	.029
x17-32	150:5	.044
x4 - x5	200:5	.058
Are- Se	250:5	.073
*2 - *4	300:5	.088
*11-344	400:5	.117
x3-x5	450:5	.131
x2 - x5	500:5	.146
x1 - x5	600:5	.175


CONNECTION DETAILS

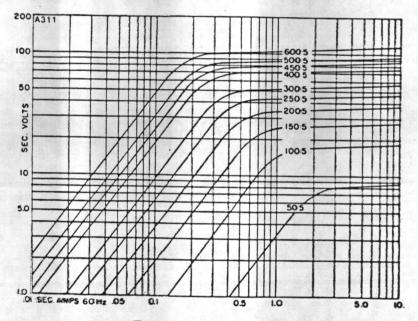



EXCITATION CURVES

ED BY SOUAARE D CON	MPANY. THIS DOCUMENT IS ISSUED IN CONFIDENCE. IT	MAY NOT BE REPRODUCED WITH ANY TIME."
REVISIONS	CT EXCITATION CURVES	DRAWN BY- FJB FRAN CHECKED BY-JUL DATE- 11-27-85
	600:5A	DATE- 11-21-85 SA-6060/6080-0030 2
	FOURRE D COMPANY HOWER EQUIPMENT GROUP SMYRNA, TENNESSEE	A-17.14333-

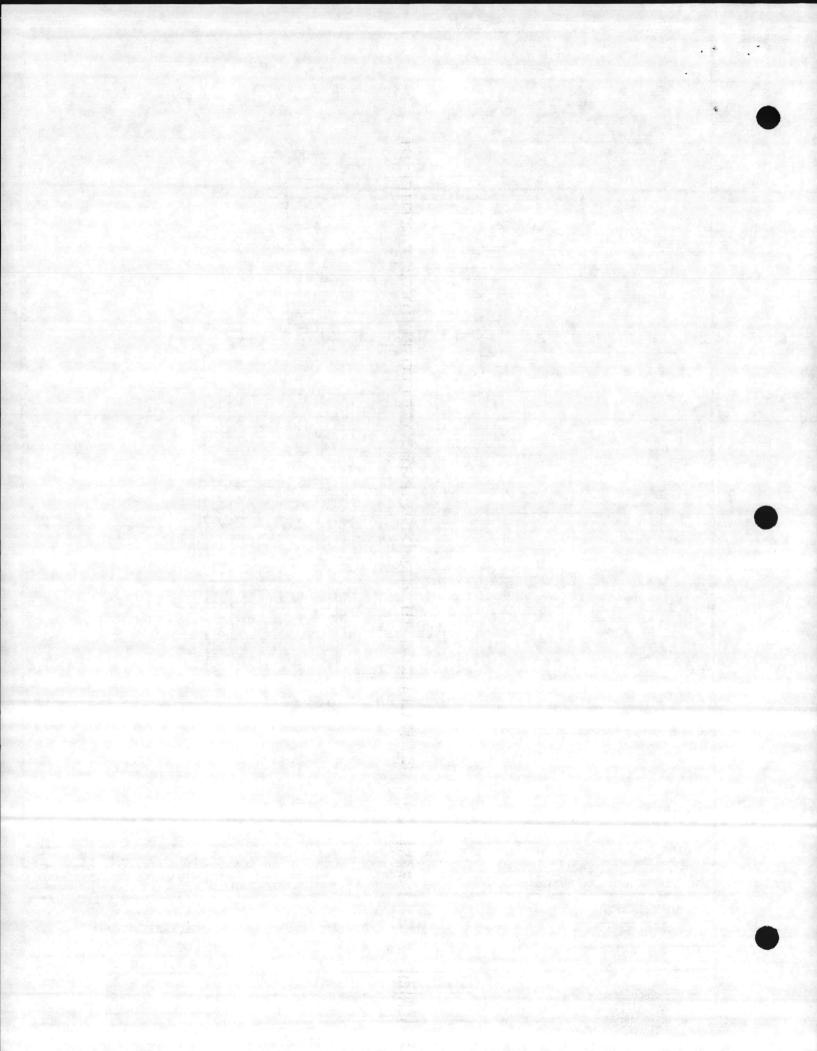

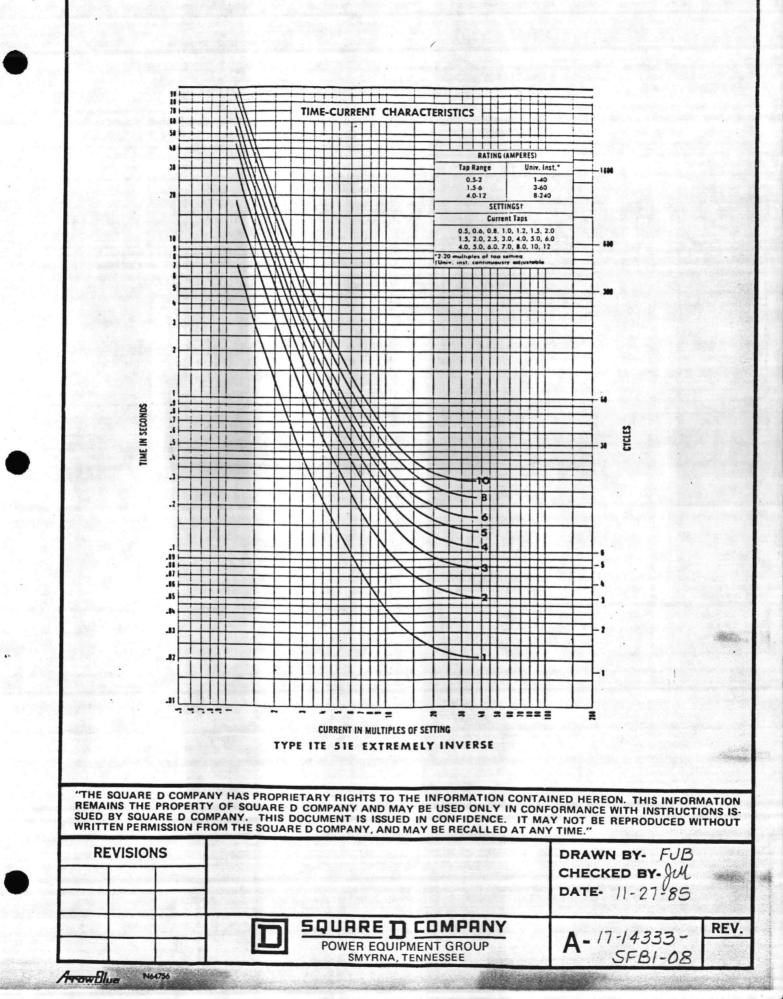

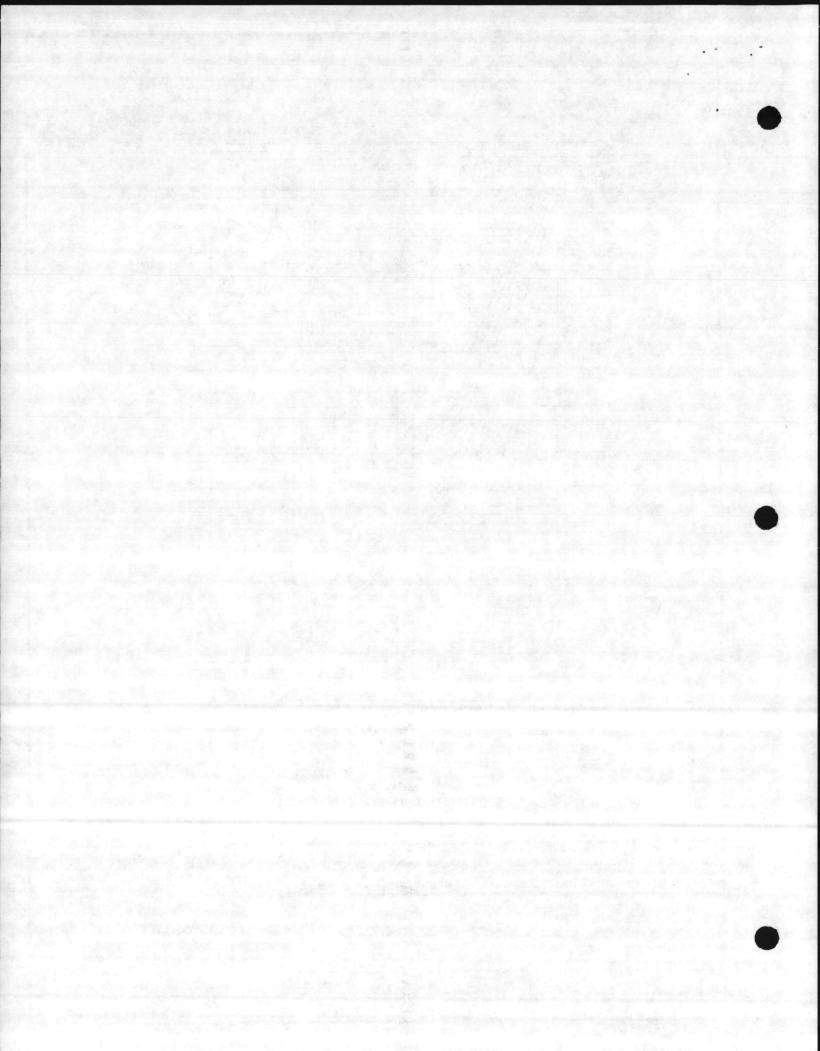

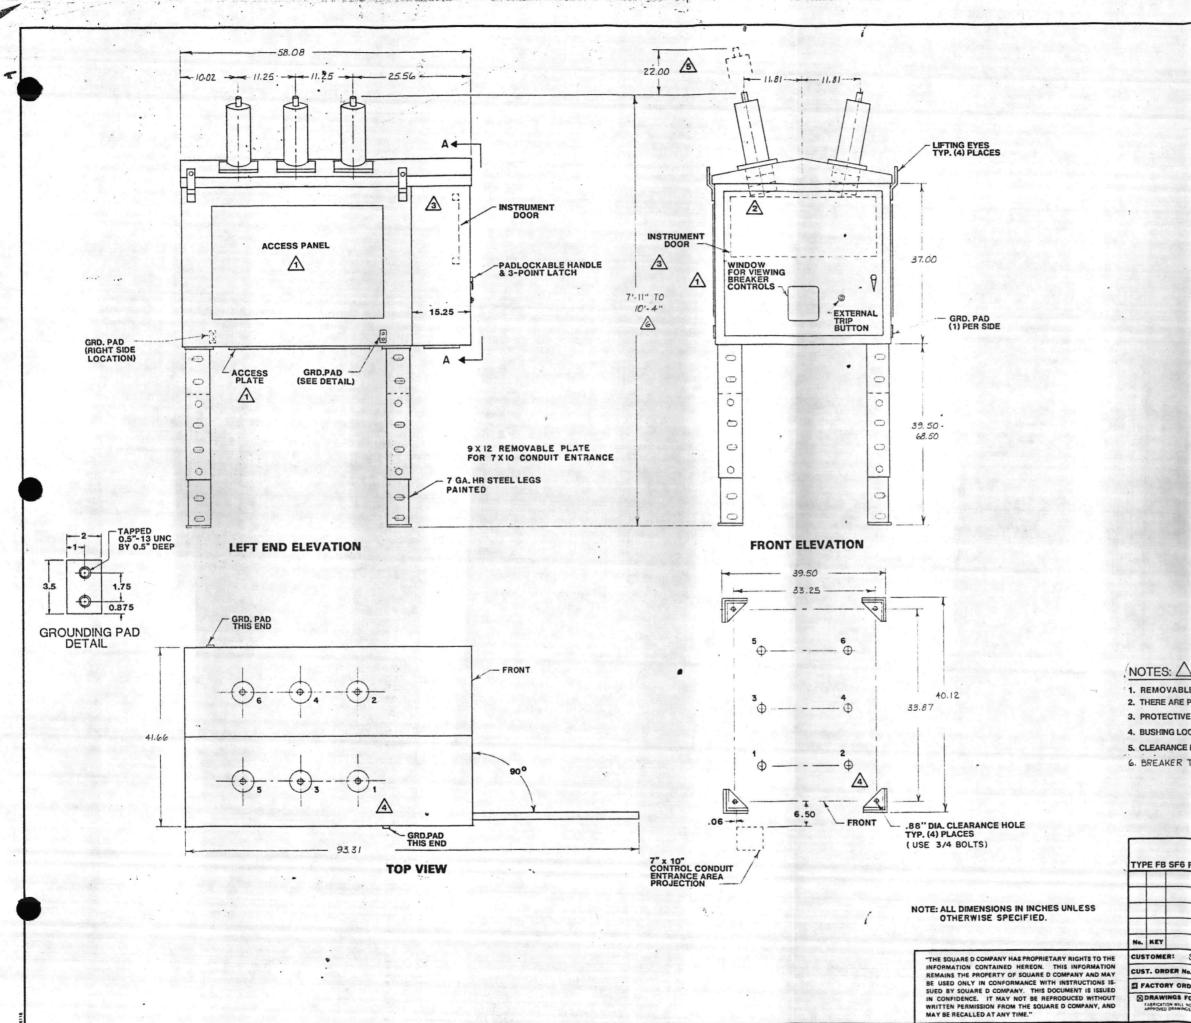


SD6060-0009 TYPE FB SF6 FLUARC SUBSTATION BREAKER RATED: 15.5 KV, 110 KV BIL, 600 A JOB TITLE: MARINE CORPS BASE LOCATION: CAMP LEJEUNE, NC ARCHITECT: ENGINEER: DESIGN BRANCH, PUBLIC WORKS DIV. No. KEY REVISIONS By DATE ELEC. CONTRACTOR CUSTOMER: SESCO STIELD OFFICE: CHARLOTTE CUST. ORDER No. 24578 -1.14D DRAWN: FUB SQUARE D COMPANY CHECKED: GUL S FACTORY ORDER No. 17-14333A POWER EQUIPMENT GROUP DRAWINGS FOR APPROVAL DRAWINGS FOR RECORD FABRICATION HAS STEN STARTED ANY CHANGES TO LAYOU' AS SHOWN MAY RESULT IN DELAY AND OR ADGITIONAL CHARGES SCALE: NTS DATE: 11-26-85 DWG. D-17-14333 - SFB1-01


	NOTES			
CATALOG NUMBER:	 FBSIC	61112		
QUANTITY:	2 600	<b>DI200</b>	□2000	□3000
RATED AMPERES:				L3000
RATED VOLTAGE (KV):	15.5	25.8	□ 38	1.1.1
BIL (KV):	110	0125	0150	200
SYSTEM VOLTAGE (KV):	12.47			1
AIC (KA SYM):	 □8 □20	25	□16 □32	□18 □40
PAINT:	ONE M	IL BAKED	ENAMEL A	ON COATING.
and the second	NON-S	TANDARD		
WEIGHT (LB.):	■1550 □ 3200	□2180 □3500	□2500 □4000	
CONTROL WIRE:	14 SI	S	DNON-S	TANDARD
CONTROL TERMINALS:	9080	KCBI	NON-S	TANDARD
CURRENT CIRCUIT WIRES:	# #12 S	IS	DNON-S	TANDARD
BUSHING STUD:	<b>Ⅲ</b> 1/8 - □ 2 - 12	12	□1 1/2 - □2 7/8	

5

QTY. RECORD DRAWINGS: 3 QTY. MAINTENANCE MANUALS:


1. REMOVABLE COVERS ON BOTH SIDES & BOTTOM 2. THERE ARE PROVISIONS FOR MOUNTING UP TO 3-CT'S PER BUSHING, 6 PER PHASE. 3. PROTECTIVE RELAYS MOUNTED ON THIS INTERIOR DOOR WHEN REQUIRED. 4. BUSHING LOCATION IDENTIFICATION NUMBERS, (SEE 3-LINE DIAGRAM). 5. CLEARANCE REQUIRED ABOVE UNIT TO REMOVE BUSHING. 6. BREAKER TO BE SHIPPED AT 9'4" HEIGHT.

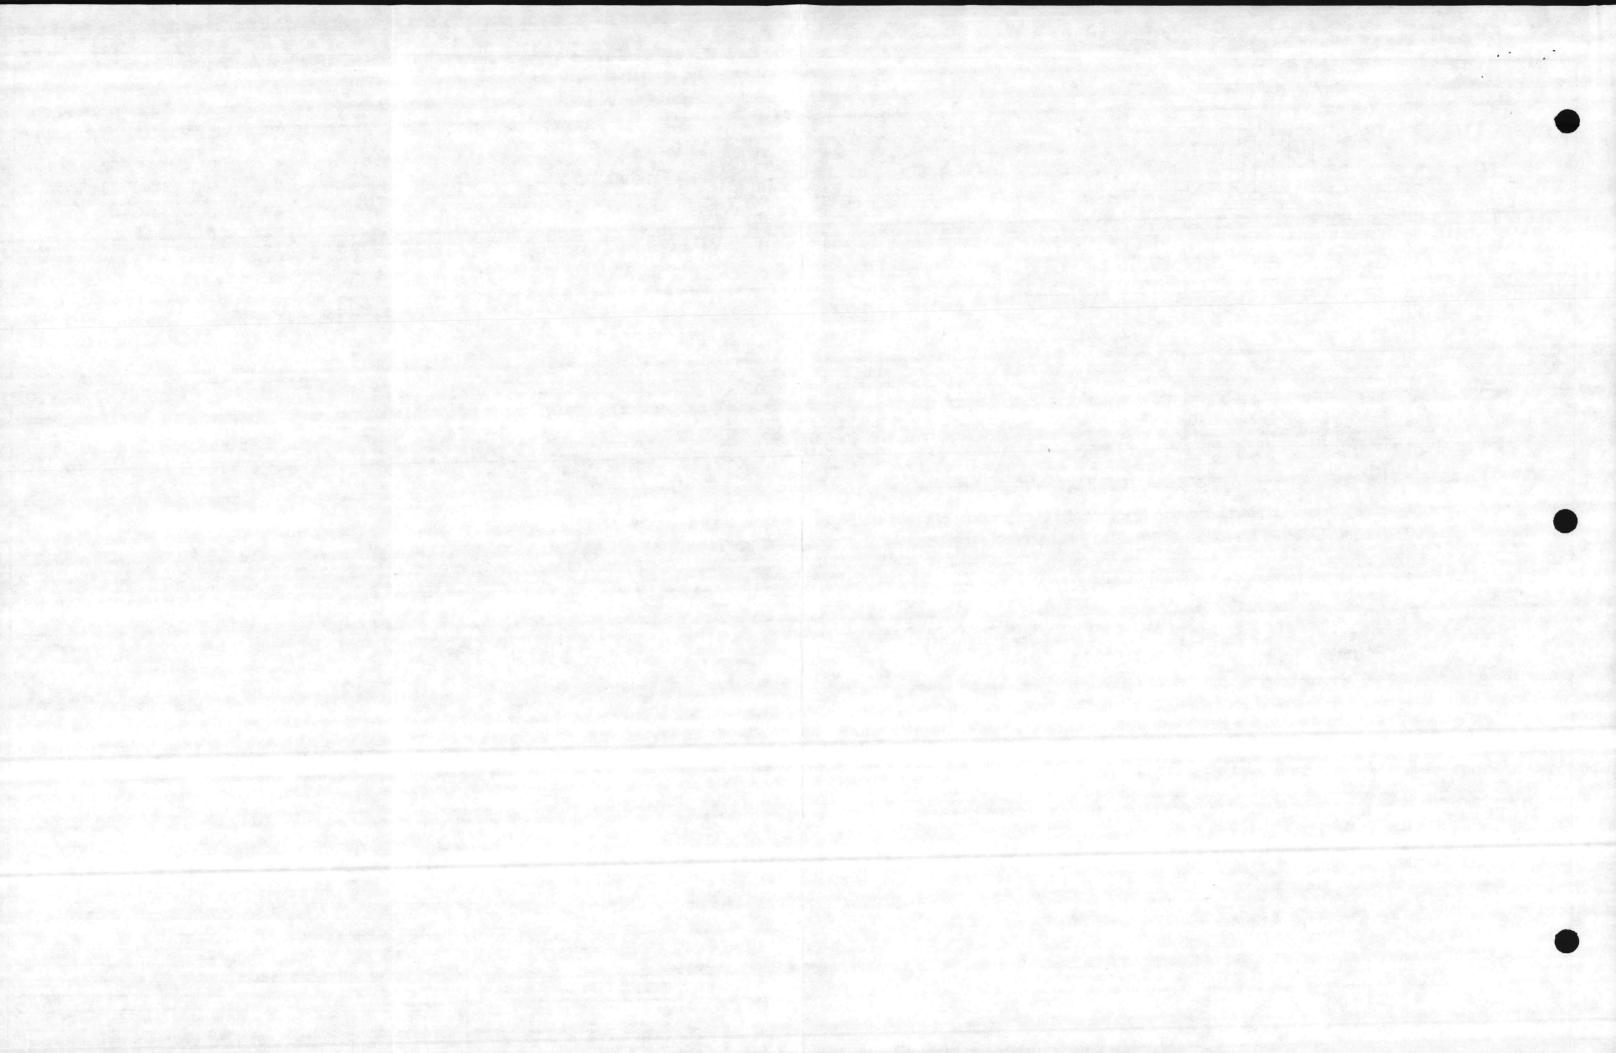


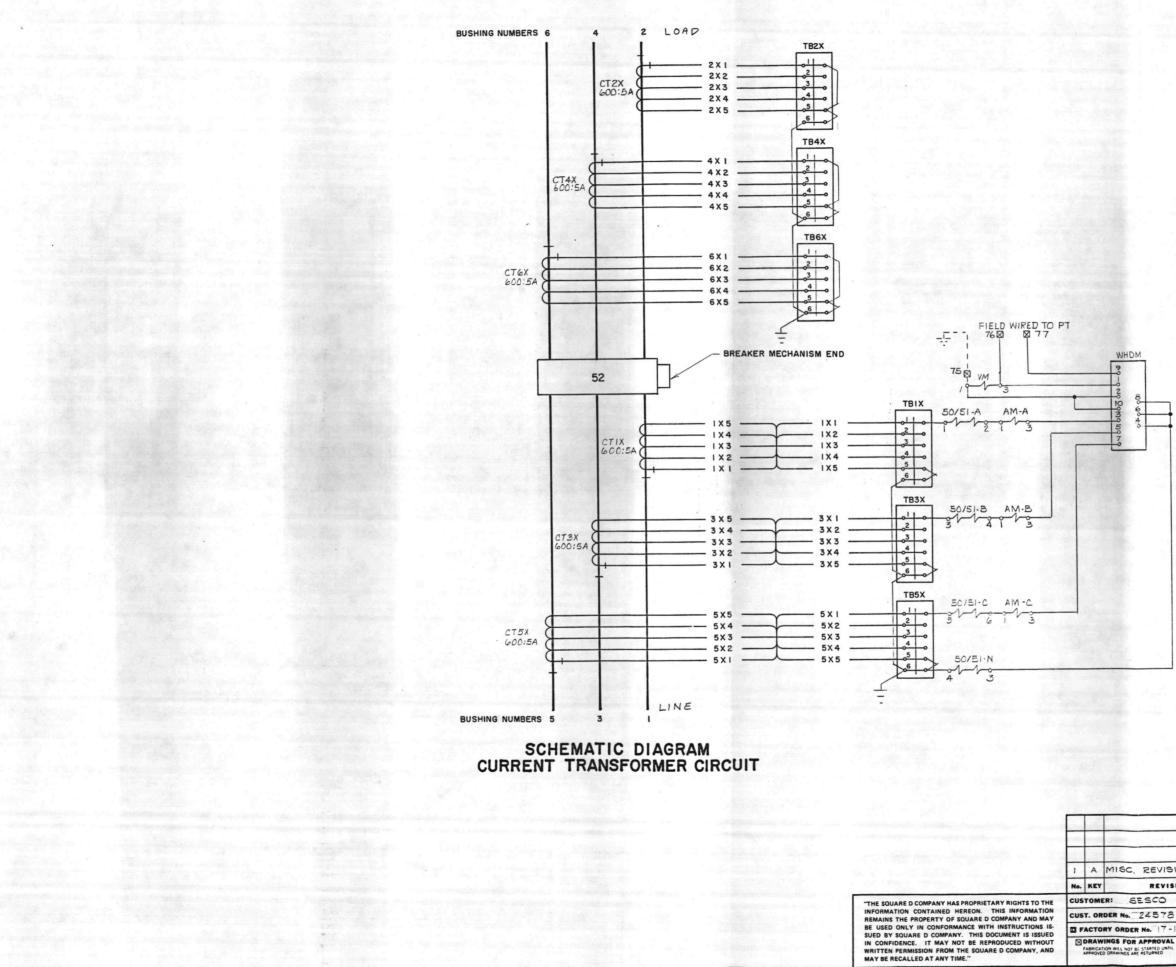

- NOTES :
- 1. ALL TERMINAL BLOCKS FOR M.R.C.T. HAVE SHORTING PROVISIONS.
- TB1X, TB3X, TB5X, ETC. TO HAVE SHORTING SCREWS INSTALLED FOR SHIPMENT.
- JUMPER WIRE SHOWN ON TERMINAL 6 OF EACH SHORT-ING TB FOR GROUND CONNECTION MUST BE LONG ENOUGH TO REACH ANY TERMINAL OF THAT BLOCK.
- 4. TO OBTAIN OTHER CT RATIOS, SEE TERMINAL CONNECTIONS ON CT NAMEPLATE DRAWING \_-05
- ALL WIRES C1, C2, C3, C01, ETC. TO BE CUT LONG ENOUGH TO REACH ANY TERMINAL ON THE ASSOCIATED TERMINAL BLOCK.

		1	JOB TITLE: MARINE CORPS BASE			
States of States and States			LOCATION: CAMP LEJEUNE, NC			
	A Constanting of the	A	ARCHITECT:			
ISC. REVISIO	ANC ZH	2-8-86	ENGINEER: DESIGN BRANCH, PUBLIC WORKS	D		
REVISIO	NS By	DATE	ELEC. CONTRACTOR			
SESCO	Statistics and strength	and in the second	FIELD OFFICE: CHARLOTTE			
R No. 24578			DRAWN: FUB	Y		
ORDER No. 17 -14	A555		CHECKED: VII POWER EQUIPMENT GROUP	-		
GS FOR APPROVAL DRAWINGS FOR RECORD			SCALE: NTS SMYRNA, TENNESSEE	REV		
WILL NOT BE STARTED UNTIL RAWINGS ARE RETURNED	CHANGES TO LAYOUT AS SHOT RESULT IN DELAY AND OR ADD CHARGES	NN MAY	DATE: 11-27-85 No. D-17-14333-SFB1-02			

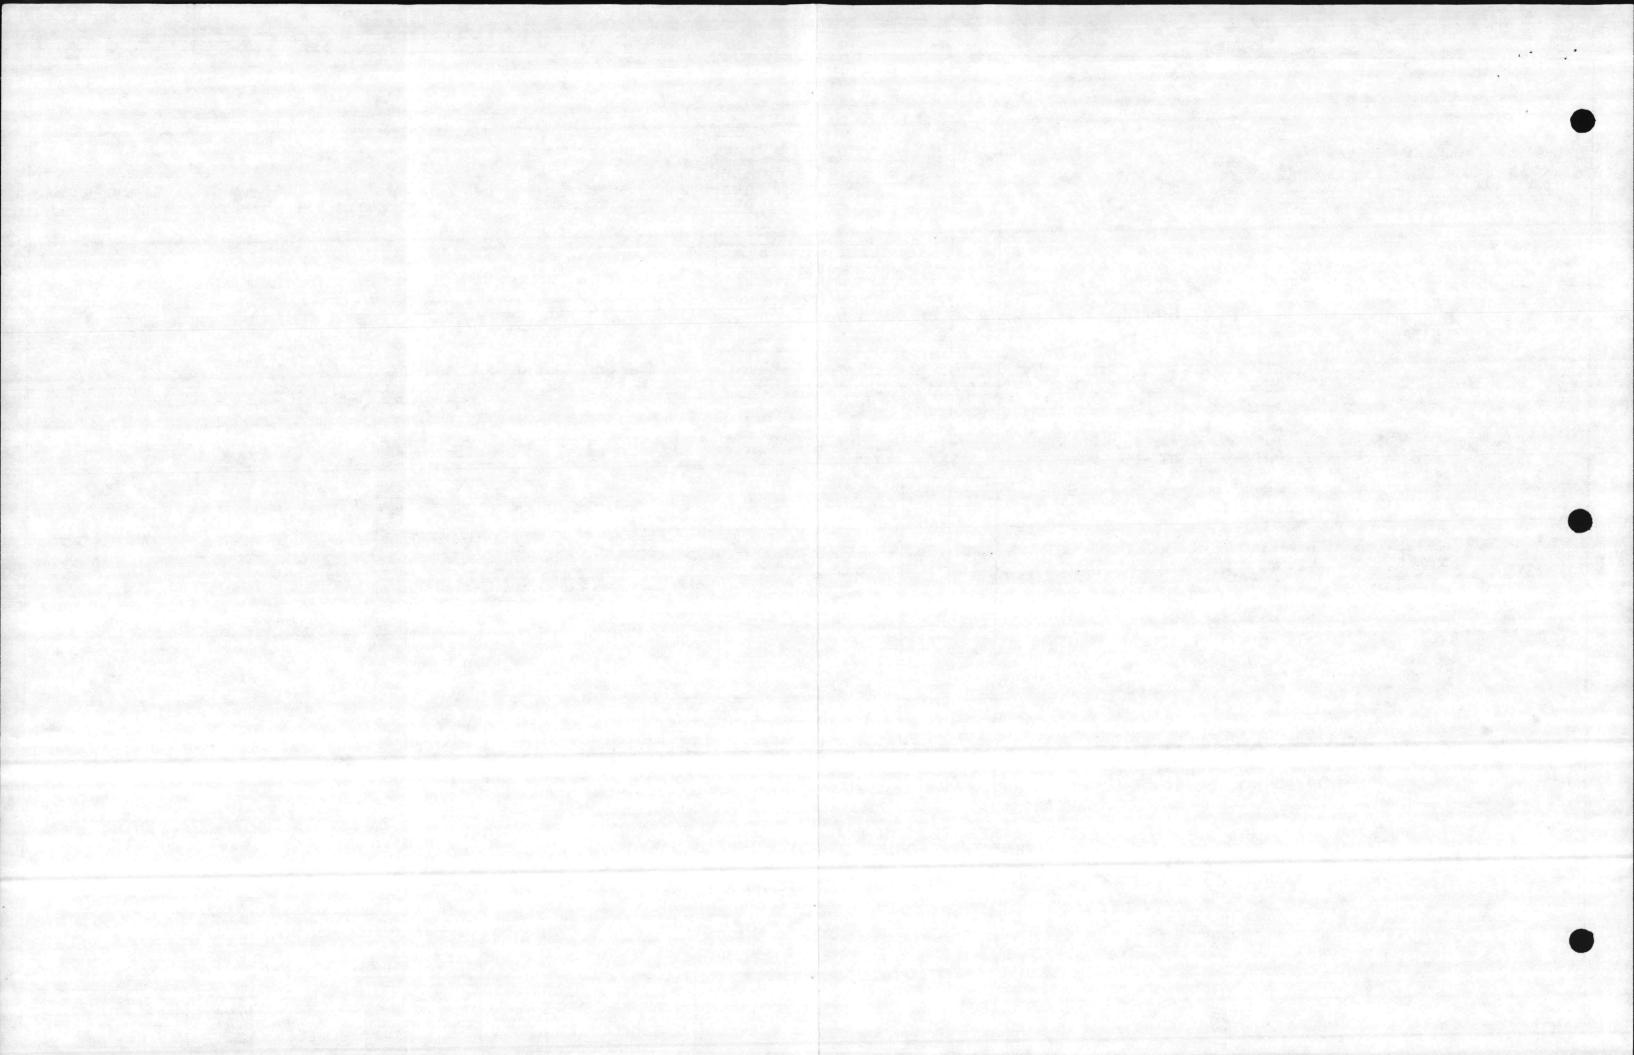

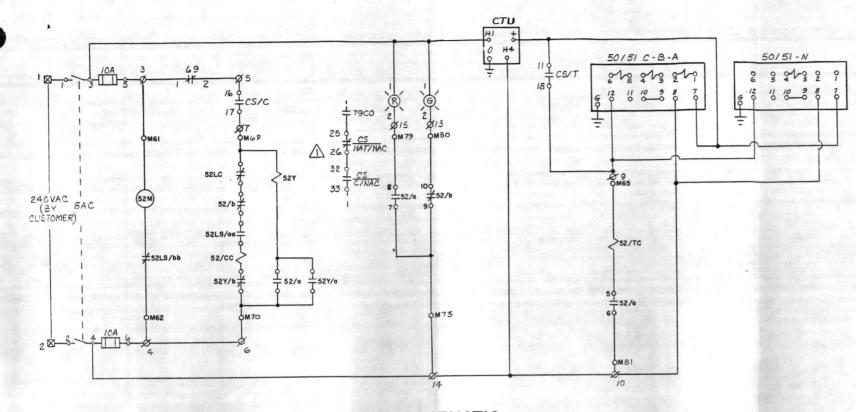

# BREAKER CONTROL SCHEMATIC

#### OPERATION OF BREAKER:

- 1. THE BREAKER WILL NOT CLOSE UNTIL THE SPRINGS ARE CHARGED
- GING OF THE CLOSING SPRINGS IS CONTROLLED BY 52LS/66. WHEN SPRINGS ARE DISCHARGED, POWER IS AVAILABLE ON TERMINALS M61 M62. THE CLOSING SPRINGS CHARGING MOTOR WILL RUN TO CHARGE CLOSING SPRINGS. WHEN THE SPRINGS ARE CHARGED, THE CONTACT /66 OPENS STOPPING THE MOTOR. 2. THE SPI AND M62 THE CLO 52LS/66 M62. TH CLOSING
- THE BREAKER IS ELECTRICALLY CLOSED BY OPERATING THE CLOSING SOLENDID 52/CC. THE CLOSING SIGNAL IS APPLIED ACROSS TERMINALS M69 AND M70. THE CLOSING SPRINGS MUST BE CHARGED (CONTACT 52LS/aa CLOSED). CONTACTS 52/A AND 52/YC PASS CURRENT TO THE CLOSING SOLENDID 52/CC. WHEN THE BREAKER CLOSES, CONTACTS 52/A AND 52Y/A CHANGE STATE. CONTACT 52/A OPENS THE CLOSING SOLENDID CIRCUIT. 3.


52/a ENERGIZES THE ANTI-PUMP RELAY 52Y, CONTACT 52Y/6 PREVENTING THE CLOSING SOLENOID FROM BEING RE-ENERGIZED 2Y IS DE-ENERGIZED, AND CONTACT 52Y SEALS THE ANTI-PUMP VIL THE CLOSE SIGNAL IS REMOVED FROM TERMINALS M69 AND

ES AS SOON AS THE CLOSING RELAY 52Y LIMITS THE BREAKER SNAL APPLIED ACROSS TERMINALS

- THE BREAKER IS ELECTRICALLY TRIPPED BY APPLYING A SIGNAL ACROSS TERMINAL M65 AND M81. IF THE BREAKER IS CLOSED (CONTACT 52/a CLOSED), THE TRIP SOLENOID WILL OPERATE, TRIPPING THE BREAKER. CONTACT 52/a OPENS, DE-ENERGIZING THE TRIP SOLENOID WHEN THE BREAKER IS OPEN.
- STATUS INDICATORS ARE CONNECTED TO TERMINALS TO INDICATE BREAKER IS OPEN OR CLOSED, CONTACT 52/0, CONNECTED TO AL M79 IS CLOSED WHEN THE BREAKER IS CLOSED. CONTACT 52/0, TED TO TERMINAL MSO IS CLOSED WHEN THE BREAKER IS OPEN. REMOTE S IF THE B TERMINAL CONNECTE 5.

LEGEND:	
	CUSTOMER TERMINAL BLOCK
ø	ANSI TERMINAL BLOCK
52/TC	BREAKER TRIP SOLENOID
52/CC	BREAKER CLOSING SOLENOID
52Y	ANTI-PUMP RELAY .
52M	CLOSING SPRINGS CHARGING MOTOR
52Y/a	ANTI-PUMP RELAY CONTACT, NORMALLY OPEN
52Y/b	ANTI-PUMP RELAY CONTACT, NORMALLY CLOSED
52LS/aa	CLOSING SPRINGS CHARGED LIMIT SWITCH, OPEN WHEN SPRING ARE NOT CHARGED. CLOSED WHEN SPRINGS ARE CHARGED.
52LS/66	CLOSING SPRINGS CHARGED LIMIT SWITCH, CLOSED WHEN SPRINGS ARE NOT CHARGED. OPEN WHEN SPRINGS ARE CHARGED.
52/a	AUXILIARY SWITCH CONTACTS, OPEN WHEN BREAKER IS IN THE TRIPPED (OPEN) POSITION. CLOSED WHEN BREAKER IS IN THE CLOSED POSITION.
52/6	AUXILIARY SWITCH CONTACTS, CLOSED WHEN BREAKER IS IN THE TRIPPED (OPEN) POSITION. OPEN WHEN BREAKER IS IN THE CLOSED POSITION.
52LC	LATCH CHECKING SWITCH
м	TERMINAL BLOCK ON BREAKER MECHANISM
8H	HEATER DISCONNECT
SAC	AC CIRCUIT DISCONNECT
69	MANUAL CLOSING SWITCH
7900	RECLOSER CUT-OUT SWITCH

DECK	CONTACTS	POSITION				
		TRIP	nat	nac	CLOSE	ZONE
1		x				
	160-1-017				x	
2	210-1-022		x	x		
	250-1-1-026		x	x		
3	320-1-1-033			x	x	
	360-1-1-037			x	X	

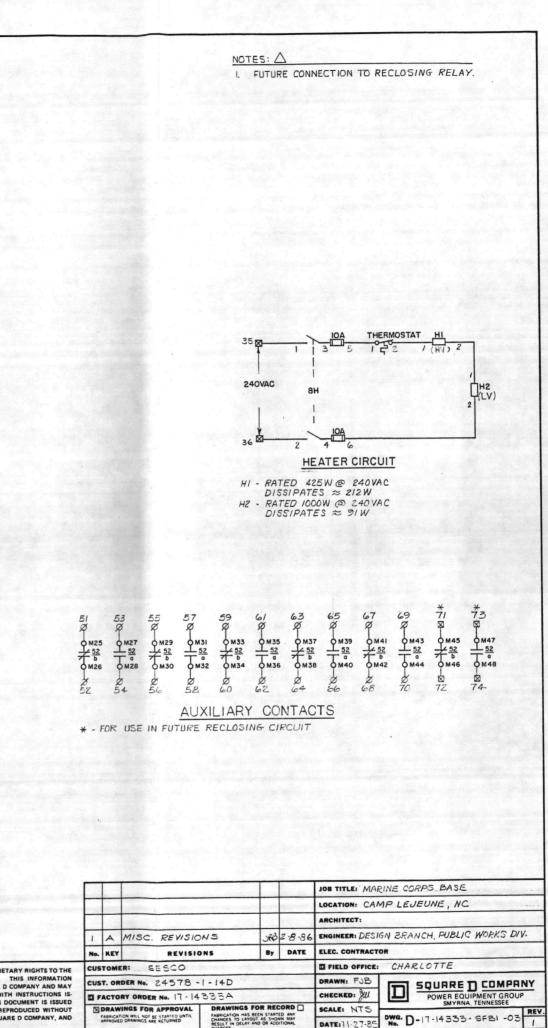

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